


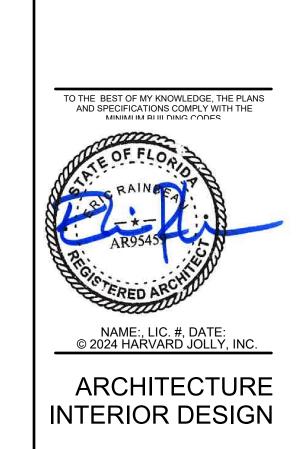

PERMIT DOCUMENTS 8/15/25 HJ COMM No: 23106.01



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FIRE PROTECTION SYMBOLS, LEGEND, NOTES AND INDEX

FIRE PROTECTION PLAN

Revision Revision Revision

ISSUE

FP-000 8/15/25


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JAKAME JAKAME


LLSBOROUGH COUNTY SHERIFF'S O SAINING ACADEMY
210 WINDHORST ROAD, TAMPA, FL 33619

DESIGN PHASE:

| Comm. No: 23106.01 | Date: 8/15/25 | Drawn by: ER

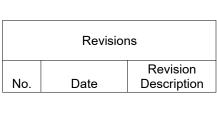


TO THE BEST OF MY KNOWLEDGE, THE PLANS AND SPECIFICATIONS COMPLY WITH THE MINIMI IM RI III DING CODES

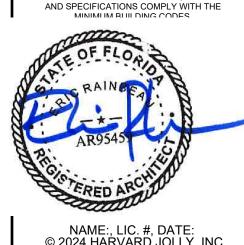

G-001

INDEX - PHASE 1

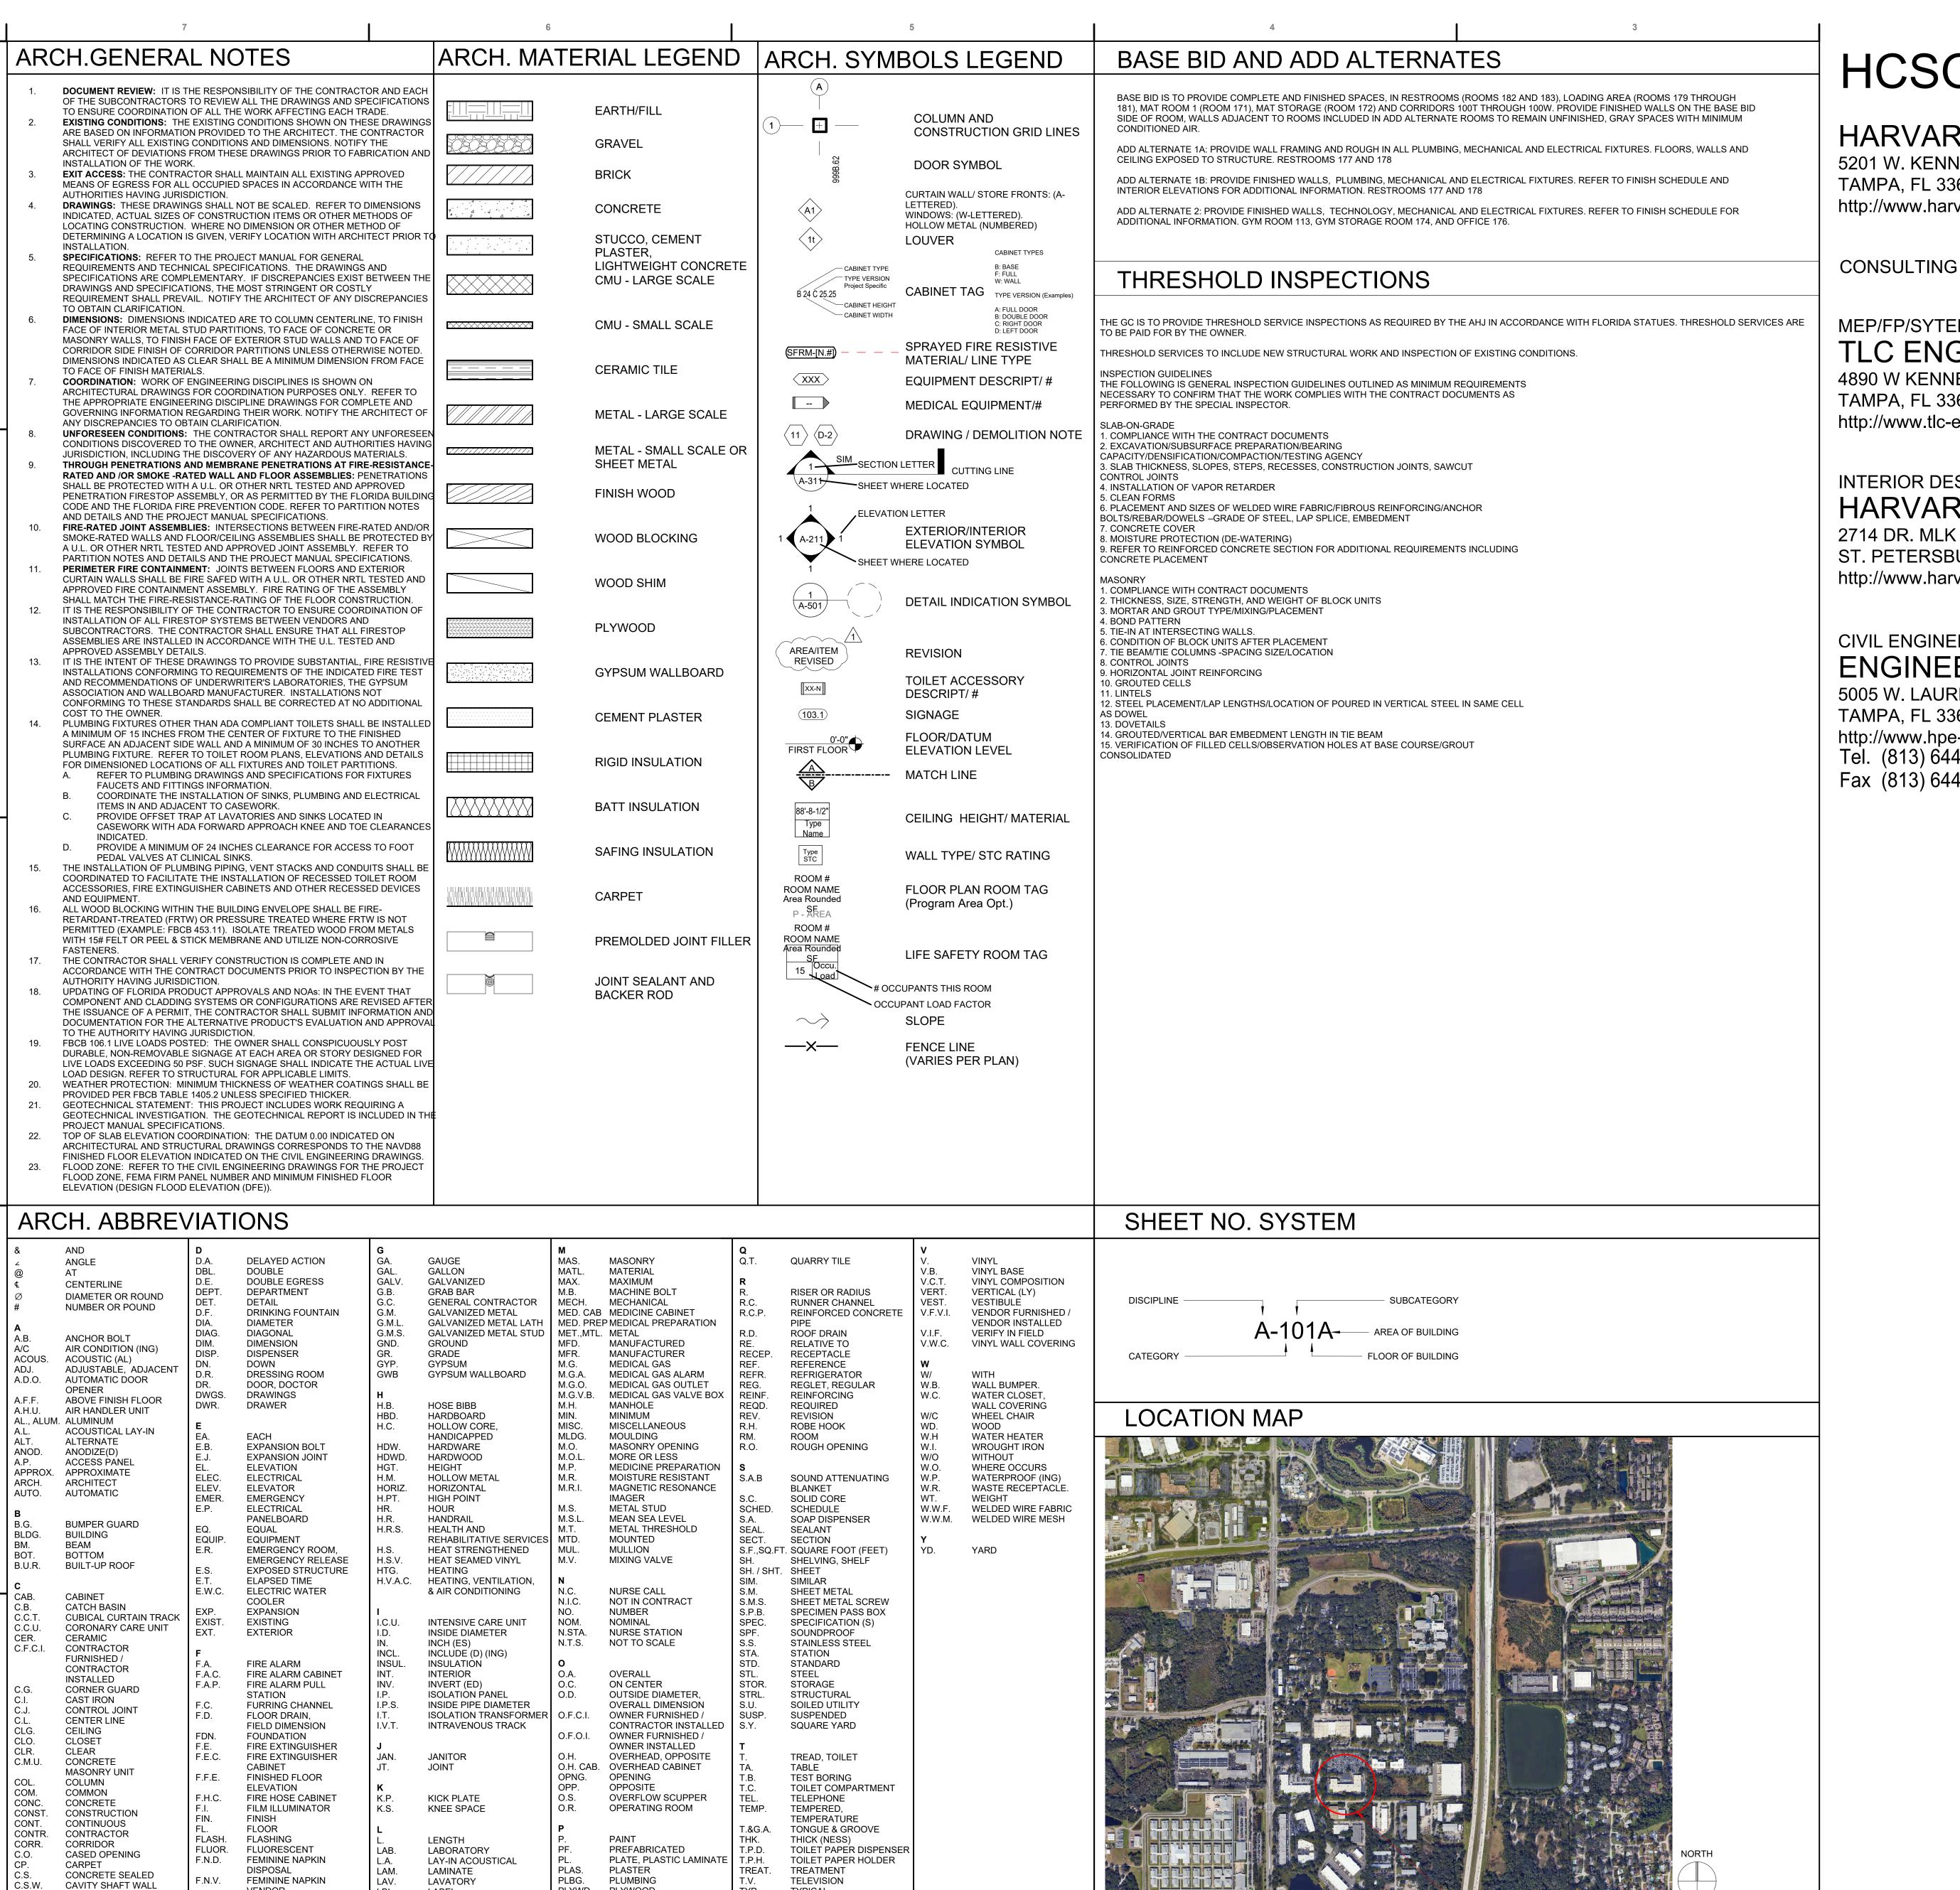

C.S.W.

C.T.W.

CERAMIC TILE

TOMOGRAPHY

**COUNTER SUNK** 

**CLEAN UTILITY** 

SCANNER

COUNTER, CENTER

CERAMIC TILE WAINSCOAT FUT.

**COMPUTED AXIAL** 

VENDOR

FOOTING

**FURRING** 

**FUTURE** 

FLUSH WOOD

FIRE PROOF(ING)

FIRE RATED

FOOT OR FEET

LINEAR FEET

LIGHTPROOF,

LIGHT WEIGHT

LEAD LINED, LIVE LOAD

LOCKER

PLYWOOD

**POLISHED** 

POINT

PAINTED

PARTITION

PRESSURE TREATED

POLYVINYL CHLORIDE

PAPER TOWEL DISPENSER

TYPICAL

UNDERCUT

UNDERCOUNTER

**UNLESS NOTED** 

OTHERWISE

UTILITY UTIL.

# HCSO TRAINING ACADEMY

# HARVARD JOLLY | PBK 5201 W. KENNEDY BLVD SUITE 515

TAMPA. FL 33609 http://www.harvardjolly.com

**CONSULTING ENGINEERS:** 

# MEP/FP/SYTEMS ENGINEER: TLC ENGINEERING 4890 W KENNEDY BLVD #250

TAMPA, FL 33609 http://www.tlc-engineers.com

#### INTERIOR DESIGN:

# HARVARD JOLLY | PBK

2714 DR. MLK JR. ST. N. ST. PETERSBURG, FL 33704 http://www.harvardjolly.com

# HARVARD • JOLLY PBK

# CIVIL ENGINEER: **ENGINEERING**

**PROJECT** 

**LOCATION** 

5005 W. LAUREL STREET, SUITE 201 TAMPA, FL 33607 http://www.hpe-fl.com Tel. (813) 644-8333 Ext. 333 Fax (813) 644-7000



HIGH POINT ENGINEERING

Comm. No: 23106.01 8/15/25 Drawn by: ER

Date

TO THE BEST OF MY KNOWLEDGE, THE PLANS



**GENERAL NOTES** LEGENDS & **ABBREVIATIONS** 

ACCESSIBLE MEANS OF EGRESS					
SPRINKLERED BUILDING  EXIT DOORS: MINIMUM WIDTH	FBC-ACCESSIBILITY SECTION 404: FBC- BUILDING SECTION 1010: 32 INCHES MINIMUM CLEAR	SECTION 7.2.1.2.3.2: 32 INCHES CLEAR MINIMUM			

FIRE SUPPRESSION SYSTEMS
EARLY WARNING SMOKE EVACUATION SYSTEMS
SCHEMATIC FIRE SPRINKLERS
STANDPIPES
PRE-ENGINEERED SYSTEMS
RISER DIAGRAM

PORTABLE FIRE EXTINGUISHER REQUIR	PORTABLE FIRE EXTINGUISHER REQUIREMENTS							
FIRE EXTINGUISHERS FOR CLASS A FIRE HAZARDS ORDINARY (MODERATE) HAZARD OCCUPANCY	FLORIDA BUILDING CODE - BUILDING SECTION 906 TABLE 906.3(1)	FLORIDA FIRE PREVENTION CODE NFPA 1 SECTION 13.6 TABLE 13.6.3.2.1.1 NFPA 101 SECTION 9.9	PROVIDED					
MINIMUM RATED SINGLE EXTINGUISHER	2-A	2-A	3-A MIN.					
MAXIMUM FLOOR AREA PER UNIT A	1,500 SQ FT	1,500 SQ FT	4,500					
MAXIMUM FLOOR AREA PER EXTINGUISHER TYPE 2A	3,000 SQ FT	3,000 SQ FT	N/A					
MAXIMUM TRAVEL DISTANCE - CLASS A	75 FEET	75 FEET	<75 FEET					
MAXIMUM FLOOR AREA PER EXTINGUISHER	11,250 SQ FT	11,250 SQ FT	<11,250 SQ FT					

1. PROVIDE EXTINGUISHERS WITH A MINIMUM 3-A RATING

ACCESSIBILITY REQUIREMENTS

OCCUPANT LOAD : GROSS / NET	REFER TO LIFE SAFETY PLANS
MEANS OF EGRESS	REFER TO LIFE SAFETY PLANS
EXIT ACCESS / EXIT / EXIT DISCHARGE	REFER TO LIFE SAFETY PLANS
STAIRS CONSTRUCTION / GEOMETRY AND PROTECTION	REFER TO LIFE SAFETY PLANS AND ARCHITECTURAL DRAWINGS
DOORS	REFER TO LIFE SAFETY PLANS AND ARCHITECTURAL DRAWINGS
EMERGENCY LIGHTING AND EXIT SIGNS	REFER TO LIFE SAFETY PLANS, ELECTRICAL DRAWINGS AND SPECS
SPECIFIC OCCUPANCY REQUIREMENTS	REFER TO CODE ANALYSIS
CONSTRUCTION REQUIREMENTS	REFER TO CODE ANALYSIS
HORIZONTAL EXITS / EXIT PASSAGEWAYS	REFER TO LIFE SAFETY PLANS

NOTE: HORIZONTAL EXITS AND EXIT PASSAGEWAYS ARE NOT PERMITTED IN EDUCATIONAL OCCUPANCIES - FBC-B 453.7.9 (SREF).

MEANS OF EGRESS				
MEANS OF EGRESS COMPONENT	FLORIDA BUILDING CODE- BUILDING, CHAPTER 10	FLORIDA FIRE PREVENTION CODE NFPA 101, CHAPTER 7 AND SPECIFIC OCCUPANCY CHAPTERS	PROVIDED	
COMMON PATH OF EGRESS TRAVEL	TABLE 1006.2.1: 75 FEET	TABLE A.7.6: 75 FEET	SEE LIFE SAFETY PLANS	
EXIT ACCESS TRAVEL DISTANCE	TABLE 1017.2: 250 FEET	TABLE A.7.6: 250 FEET	SEE LIFE SAFETY PLANS	
MINIMUM CORRIDOR WIDTH	SECTION 1020.3: 44 INCHES AND AS SIZED PER SECTION 1005	SECTION 7.3.4: 44 INCHES AND AS SIZED PER TABLE 7.3.3.1	SEE LIFE SAFETY PLANS	
MAXIMUM DEAD END CORRIDOR	SECTION 1020.5: 20 FEET	TABLE A.7.6: 20 FEET	SEE LIFE SAFETY PLANS	
MINIMUM NUMBER OF EXITS:	TABLE 1006.3.2: <500 OCCUPANTS: (2) EXITS >500 <1000 OCCUPANTS: (3) EXITS >1000 OCCUPANTS: (4) EXITS	SECTION 7.4: <500 OCCUPANTS: (2) EXITS >500 <1000 OCCUPANTS: (3) EXITS >1000 OCCUPANTS: (4) EXITS	SEE LIFE SAFETY PLANS	
FIRST FLOOR	794 OCCUPANTS: 3 EXITS		4 EXITS	
PANIC AND FIRE EXIT HARDWARE	SECTION 1010.2.9	SECTION 7.2.1.7	YES	
RAMP WIDTH REQUIRED WHEN USED AS A COMPONENT OF A MEANS OF EGRESS	SECTION 1012.1	SECTION 7.2.5	N/A	

APPROVED PRODUCTS: ALSO NOTED AS 'LISTED' PRODUCTS/ SYSTEMS

SUBCATEGORY

HOLLOW METAL SWINGING

CATEGORY

WINDOWS

ROOFING

PANEL WALLS

STRUCTURAL COMPONENTS

ENVELOPE

NEW & INNOVATIVE

PRODUCTS (OTHER)

KEY DOCUMENTATION

"A" A TEST REPORT FROM AN APPROVED LABORATORY

"B" A LISTING OR LABEL FORM AN APPROVED CERTIFICATION AGENCY

EXTERIOR DOORS

MANUFACTURER

PRODUCT NUMBER

TORNADO STEEL

MANUF:ALLEGION (C)
SERIES# HURRICANE
DROPS

FL-41734
DROPS

1. FLORIDA PRODUCT APPROVAL NUMBERS FOR EXTERIOR CLADDING/ COMPONENTS: RULE 61G20-3 F.A.C. PRODUCT

JURISDICTION FOR THE ALTERNATE PRODUCT'S EVALUATION AND APPROVAL.

AN EVALUATION REPORT FROM AN APPROVED EVALUATION ENTITY OR

HAS BEEN PROVIDED IN THE ABOVE SCHEDULE UNDER THE FOLLOWING KEY LISTING.

FLORIDA LICENSED PROFESSIONAL ENGINEER (P.E.) OR REGISTERED ARCHITECT(R.A.).

INCLUSION OF A PRODUCT IN THIS SCHEDULE DOES NOT IMPLY OR PRESUME THAT THE PRODUCT LISTED WILL BE INSTALLED IN THIS PROJECT. ALTERNATE PRODUCTS COMPLYING WITH CODE REQUIREMENTS MAY BE UTILIZED UPON EVALUATION, ACCEPTANCE, AND APPROVAL BY THE AUTHORITY HAVING JURISDICTION. IT IS THE CONTRACTOR'S RESPONSIBILITY TO SUBMIT INFORMATION AND DOCUMENTATION THAT MAY BE REQUIRED BY THE AUTHORITY HAVING

SEE STRUCTURAL FOR APPLICABLE WIND SPEED CLASSIFICATION AND RISK CATEGORY OF PROJECT. DOCUMENTATION DEMONSTRATING A PRODUCT'S COMPLIANCE WITH THE CODE, AS EVALUATED THROUGH CODE ADOPTED METHODS,

DOCUMENTATION TYPE (SEE KEY BELOW)

LAB NAME | FLORIDA | MIAMI-DADE | P.E./R.A. | EXPIRATION

TEST NO. APPROVAL NOA NAME DATE

HERMES MM-DD-YY

1. CORRIDORS SERVING LESS THAN 100 OCCUPANTS: 44 INCH MIN. WIDTH.

PLUMBING FIXTURE REQUIREMENTS: FBC PLUMBING CHAPTER 4, TABLE 403.1

ASSEMBLY	WC (URINALS)	1	LAVATORIES		BATHTUBS	DRINKING	OTHER
USE:	MALE	FEMALE	MALE	FEMALE	SHOWERS	FOUNTAIN	OTHER
TOTAL OCCUPANTS - -/2= M F	1 PER 125	1 PER 65	1 PER 200	1 PER 200	N/A	1 PER 500	1 SERVICE SINK
REQUIRED	4	6	2	2		1	2
PROVIDED	22	15	11	16	40	4	2

1. FBC-PLUMBING SECTION 403.1.3: IN ASSEMBLY OCCUPANCIES, RESTROOMS OPEN TO THE PUBLIC MUST HAVE A RATIO OF 3:2 WATER CLOSETS AS THE COMBINED TOTAL OF WATER CLOSETS AND URINALS PROVIDED FOR MEN, UNLESS THERE ARE TWO OR FEWER SUCH FIXTURES FOR MEN. THE RATIO ESTABLISHED BY POTTY PARITY IS NOT REQUIRED TO BE MAINTAINED FOR THE ADDITIONAL FIXTURES PROVIDED IN EXCESS OF THE MINIMUM REQUIRED FIXTURES.

APPLICABLE CODES CODE EDITIONS REFERENCED BELOW INCLUDE SUPPLEMENTS AND APPLICABLE AMENDMENTS

BUILDING CODE: FLORIDA BUILDING CODE (FBC) 8TH EDITION (2023)

ACCESSIBILITY CODE: FBC-ACCESSIBILITY 8TH EDITION (2023): FLORIDA ACCESSIBILITY CODE FOR BUILDING CONSTRUCTION EXISTING BUILDING: FBC-EXISTING BUILDING 8TH EDITION (2023) PRESCRIPTIVE COMPLIANCE METHOD ALTERATION LEVEL 3 MECHANICAL CODE: FBC-MECHANICAL 8TH EDITION (2023)

ELECTRICAL CODE: FBC-BUILDING, CHAPTER 27; NFPA 70-2020 NATIONAL ELECTRIC CODE (N.E.C) PLUMBING CODE: FBC PLUMBING 8TH EDITION (2023)

GAS FUEL CODE: FBC GAS FUEL 8TH EDITION (2023)

FIRE AND LIFE SAFETY CODES: FLORIDA FIRE PREVENTION CODE (FFPC) 8TH EDITION based on NFPA 1, FIRE CODE 2021 EDITION and NFPA 101, LIFE SAFETY CODE 2021 EDITION


BUILDING HEIGHTS AND AREAS: EXISTING BUILDING				
	FLORIDA BUILDING CODE - BUILDING CHAPTER 5	PROVIDED		
AUTOMATIC SPRINKLER SYSTEM		YES		
TYPE OF CONSTRUCTION	TYPE II B			
TABLE 504.3 ALLOWABLE HEIGHT IN FEET ABOVE GRADE PLANE	NS: 55 FEET S: 75 FEET	20 FEET		
TABLE 504.4 ALLOWABLE NUMBER OF STORIES ABOVE GRADE PLANE	NS: 2 STORIES S: 3 STORIES	1 STORIES		
TABLE 506.2 ALLOWABLE AREA FACTOR At = NS, S1, S13R, OR SM AS APPLICABLE	NS: 9,500 SQUARE FEET S1: 38,000 SQUARE FEET			
SECTION 506.2 ALLOWABLE AREA DETERMINATION	EQUATION 5-1, 5-2 OR 5-3 AS APPLICABLE Aa =	34,040 SQ FT		
TABLE 506.3.3 FRONTAGE INCREASE FACTOR	FRONTAGE INCREASE FACTOR If = 0.75			

	FLORIDA BUILDING CODE BUILDING	FLORIDA FIRE PREVENTION CODE NFPA 101	PROVIDED	
BUILDING ELEMENT	TABLE 601: CONSTRUCTION CLASSIFICATION TYPE II B	SECTION 8.2.1.2		
PRIMARY STRUCTURAL FRAME	0 - HOUR	0 - HOUR	0 - HOUR	
BEARING WALLS				
EXTERIOR (NOT LESS THAN RATING BASED ON FIRE SEPARATION DISTANCE: TABLE 705.5	0 - HOUR	0 - HOUR	0 - HOUR	
INTERIOR	0 - HOUR 0 - HOUR		0 - HOUR	
NON-BEARING WALLS AND PARTITIONS EXTERIOR	BASED ON FIRE SEP.	ARATION DISTANCE: TABLE 705.5		
NON-BEARING WALLS AND PARTITIONS INTERIOR	0 - HOUR	0 - HOUR	0 - HOUR	
FLOOR CONSTRUCTION AND ASSOCIATED SECONDARY MEMBERS	0 - HOUR	0 - HOUR	0 - HOUR	
ROOF CONSTRUCTION AND ASSOCIATED SECONDARY MEMBERS	0 - HOUR	0 - HOUR	0 - HOUR	

FLORIDA BUILDING	G CODE - BUILDING	FLORIDA FIRE PREVENTION CODE NFPA 101
CHAPTER 3 USE AND OCCUPANCY CLASSIFICATION	CHAPTER 3, SECTION 302	CHAPTER 6, SECTION 6.1.1
	CHAPTER 5, SECTION 508 CHAPTER 6, SECTION 601	
	OCCUPANCY AND USE DESIGNATION A-3	OCCUPANCY CLASSIFICATION ASSEMBLY
CHAPTER 5 OCCUPANCY GROUP AND SPECIAL OCCUPANCY REQUIREMENTS	508.2 ACCESSORY OCCUPANCIES AGGREGATE SHALL NOT OCCUPY MORE THAN 10% OF STORY LOCATED	6.1.14.1.3 AND 6.1.14.1.4 ACCESSORY OCCUPANCIES STORAGE
	508.3 NONSEPARATED OCCUPANCIES A-3	6.1.14.3 MIXED OCCUPANCIES ASSEMBLY BUSINESS
	508.4 SEPARATED OCCUPANCIES N/A	6.1.14.4 SEPARATED OCCUPANCIES
	509 INCIDENTAL USES	6.1.14.1.3.1 INCIDENTAL USES
CONSTRUCTION CLASSIFICATION	SECTION 601 TYPE II B	SECTION 8.2.1.2 TYPE II 000

	FLORIDA BUILDING CODE BUILDING CHAPTER 8	FLORIDA FIRE PREVENTION CODE NFPA 101 CHAPTER 10 AND SPECIFIC OCCUPANCY CHAPTERS 11-43	PROVIDED
INTERIOR WALL AND CEILING FINISH REQUIREMENTS BY OCCUPANCY  ASTM E84 or UL 723 FLAME SPREAD INDEX SMOKE DEVELOPMENT INDEX	SECTION 803 AND TABLE 803.11 GROUP A-3; SPRINKLERED  EXIT STAIRS, RAMPS, PASSAGEWAYS: CLASS A, B CORRIDORS, EXIT ACCESS STAIRS, AND RAMPS: CLASS A, B ROOMS AND ENCLOSED SPACES: CLASS A, B, C*	SECTION 10.2.3 AND TABLE A.10.2.2 OCCUPANCY: A-NEW; SPRINKLERED EXITS: CLASS A EXIT ACCESS CORRIDORS: CLASS A, B OTHER SPACES: CLASS A, B, C*	CLASS A CLASS B CLASS C
INTERIOR FLOOR FINISH REQUIREMENTS BY OCCUPANCY  ASTM E648 or NFPA 253 CRITICAL RADIANT FLUX  DOC FF-1 PILL TEST (CPSC 16 CFR PART 1630) or ASTM D2859	SECTION 804 GROUP A-3; SPRINKLERED STAIRWAYS, RAMPS, EXIT PASSAGEWAYS, CORRIDORS: CLASS I OR II	SECTION 10.2.7 AND TABLE A.10.2.2 OCCUPANCY: A-NEW; SPRINKLERED EXITS: CLASS I OR II EXIT ACCESS CORRIDORS: CLASS I OR II OTHER SPACES: CLASS N/A	CLASS I CLASS II

ACADEMY HORST ROAD, " Comm. No: 23106.01 Date: 8/15/25 Drawn by: ER

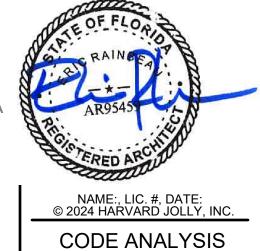

**PHASING PLAN NOTES OCCUPANCY TABLE: FIXTURES TABLE:** 

YEAR PERIOD, ALTHOUGH LATER STAGES HAVE NOT BEEN SCHEDULED TO DATE. PHASE 1 BEGINS IN THE NORTHEAST CORNER OF THE BUILDING, REPLACING A DINING AREA AND OPEN OFFICE SPACE WITH A WORKOUT GYM AND LOCKER ROOM

THE ENTIRE BUILDING IS TO BE RENOVATED OVER A FIVE

FACILITIES. PHASE 2 WILL BE CONSIST OF CLASSROOMS, STUDY ROOMS, DINING AREA AND ADDITIONAL CADET TRAINING ROOMS, CONSTRUCTED IN 2026.

PHASE 3 WILL BE OFFICES, TBD. PHASE 1 IS THE ONLY PHASE ANTICIPATED TO HAVE ANY ADDITIONAL LAVATORIES, WATER CLOSETS, URINALS OR

PHASE 1 WORK IS TO BE SEGREGATED FROM THE REMAINDER OF THE FACILITY, AS A PORTION OF THE BUILDING WILL BE IN USE TEMPORARILY. AS WELL AS THE POSSIBILITY OF PHASE 2 CONSTRUCTION BEGINNING BEFORE PHASE 1 IS COMPLETE.

#### **GENERAL NOTE:**

FUTURE PHASE INFORMATION IS FOR INFORMATIONAL PURPOSES ONLY AND ARE IS SUBJECT TO CHANGE. WORK IN FUTURE PHASES WILL BE UNDER SEPARATE PERMIT AND WILL FOLLOW ALL APPLICABLE CODES AT THE TIME OF PERMIT.

PHASE 1									
REQUIRED WC			LAVS		PROVIDED		LAVS		
MALE		FEMALE	MALE	FEMALE	MALE	FEMALE	MALE	FEMALE	
	3:05	2:05	4:20	4:20					
	2	4	2	2	18	10	8	12	
					16	6	6	10	OVER BY

PHASE 2								
REQUIRED V	VC	LAVS		PROVIDED		LAVS		1
MALE	FEMALE	MALE	FEMALE	MALE	FEMALE	MALE	FEMALE	
3:05	2:05	4:20	4:20					
8	15	5	5	8	10	6	8	
				0	-5	1	3	OVER

PHASE 3		=						
REQUIRED V	VC	LAVS	AVS			LAVS		
MALE	FEMALE	MALE	FEMALE	MALE	FEMALE	MALE	FEMALE	
1:25 1ST 50		1:40 1ST 80						
1:50		2:20						
2	2	2	2	0	0	0	0	
				-2	-2	-2	-2	UNDER BY
				14	-1	5	11	TOTAL +/-

PLUMBING FIXTURE REQUIREMENTS: FBC PLUMBING CHAPTER 4, TABLE 403.1

ASSEMBLY	WC (URINALS)		LAVATORIES		BATHTUBS	DRINKING	OTHER
USE:	MALE	FEMALE	MALE	FEMALE	SHOWERS	FOUNTAIN	OTHER
TOTAL OCCUPANTS - -/2= M F	1 PER 125	1 PER 65	1 PER 200	1 PER 200	N/A	1 PER 500	1 SERVICE SINK
REQUIRED	12	21	9	9	9	9	1
PROVIDED	26	20	14	20	36	6	3

1. FBC-PLUMBING SECTION 403.1.3: IN ASSEMBLY OCCUPANCIES, RESTROOMS OPEN TO THE PUBLIC MUST HAVE A RATIO OF 3:2 WATER CLOSETS AS THE COMBINED TOTAL OF WATER CLOSETS AND URINALS PROVIDED FOR MEN, UNLESS THERE ARE TWO OR FEWER SUCH FIXTURES FOR MEN. THE RATIO ESTABLISHED BY POTTY PARITY IS NOT REQUIRED TO BE MAINTAINED FOR THE ADDITIONAL FIXTURES PROVIDED IN EXCESS OF THE MINIMUM REQUIRED FIXTURES. 2. IN THE FUTURE PHASE, WHERE THE THE FEMALE LAVATORY COUNT IS INADEQUATE, AOR WILL PURSUE EXCEMPTION OF ABOVE POTTY PARITY COUNTS DUE TO ACTUAL PERCENTAGE OF MALE/FEMALE OCCUPANTS.

IXIVI #	INVI INAIVIL	31	/000	101 000
118	IDF	146	300	1
144	AUDIOVIS	118	300	1
145	MDF	200	300	1
168	MDF ROOM	168	300	
175	GYM	3617	50	73
171	MAT ROOM	1579	5	316
172	MAT STORAGE	337	300	
174	GYM STORAGE	347	300	9
176	OFFICE	147	150	,
177	WOMENS RR/SHOWERS	523	50	1
178	MENS RR/SHOWERS	516	50	1
179	LOADING	254	300	3
180	ELECT RM	43	-	
181	STORAGE	87	300	
181A	UTILITY	48	-	j
182	WOMENS SHOWER LOCKERS	738	50	1
183	MENS SHOWER LOCKERS	1417	50	2
100W	CORRIDOR	159	-	j
100V	CORRIDOR	416	-	
100U	CORRIDOR	339	-	j
100T	CORRIDOR	368	-	(
202	RISER ROOM	140	300	
	TOTAL	11707		460


PHASE 1 ASSEMBLY


PHASE 2 ASSEMBLY

RM#	RM NAME	SF	/OCC	TOT OCC
116	SECURE STORAGE	785	300	3
117	TRAINING STORAGE	580	300	2
119	ELECT	209	:-	0
130	RESTROOM	238	Ę <b>–</b>	0
131	RESTROOM	288	,_	0
132	JANITOR	30	300	1
132A	STORAGE	259	300	1
133	BREAKROOM	407	15	28
134	CLASSROOM	812	15	55
135	CLASSROOM	1069	15	70
136	CLASSROOM	1635	15	109
137	CLASSROOM	1595	15	107
138	CLASSROOM	1622	15	109
139	CLASSROOM	1580	15	106
140	CLASSROOM	607	15	41
141	CLASSROOM	670	15	45
142	QUIET ROOM	213	15	15
143	CLASSROOM	1347	15	90
146	STORAGE	146	300	1
147	ADA TLT RM	62	1-	0
148	RECEPTION	86	150	1
149	LOBBY	565	7	81
150	CONFERENCE ROOM	548	15	22
151	VIRTUAL STUDIO	294	15	35
152	NURSING	76	150	1
153	ELECT	58	300	1
154	COPY	139	150	1
155	LIVE TRAINING	2208	7	316
156	KITCHEN/LIVING	338	50	7
157	TOILET	45	7-	0
158	BEDROOM	188	50	4
159	CLASSROOM	1603	15	107
160	MAT ROOM 2	1536	5	308
161	STORAGE	307	300	2
162	LOCKERS	1629	50	33
163	STUDY ROOM	537	15	36
164	OFFICE	145	150	1
165	OFFICE	144	150	1
166	DINING	2433	15	163
167	STORAGE	201	300	1
169	RESTROOM	232	50	5
170	RESTROOM	251	50	7
173	CUST	29	300	1
202	RISER ROOM	140	300	1
100J	CORRIDOR	351	:=	0
100L	CORRIDOR	476	:-	0
100M	CORRIDOR	623	:=	0
1000	CORRIDOR	504		0
100P	CORRIDOR	232	i <del>-</del>	0
Marketon was	1		-	

100S1	(	CORRIDOR		2	84	- (
1821		CORRIDOR		3	70	- (
		TO	TAL	328	13	1918
PHASE 3	BUS	SINESS				
RM#		RM NAME		SF	/OCC	TOT OCC
100B		CORRIDOR		291	_	C
100D		CORRIDOR		299	-	C
100E		CORRIDOR		513	-	C
101		OFFICE		235	150	2
102		OFFICE		179	150	2
103		OFFICE		190	150	2
104		OFFICE		192	150	2
105		CLOSET		300	300	1
106		OFFICE		239	150	2
107		OFFICE		132	150	1
108		OFFICE		163	150	2
109		OFFICE		129	150	1
110		OFFICE		172	150	2
111		OFFICE		149	150	1
112		OFFICE		173	150	2
113		OFFICE		165	150	2
114		OFFICE		411	150	3
115		OFFICE		231	150	2
120		OFFICE		172	150	2
121		CONFERENCE		379	15	26
122		OFFICE		159	150	2
123		OFFICE		162	150	2
124		OFFICE		209	150	2
125		OFFICE		204	150	2
126		OFFICE		173	150	2
127		OFFICE		162	150	2
128		WORKROOM		4826	150	33
					TOTAL	100
				G	RAND TOTAL	2484


CORRIDOR

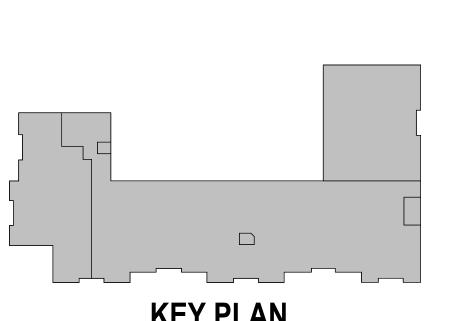


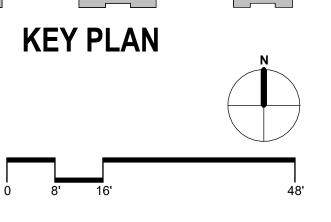


CODE REVIEW PLAN

G-011

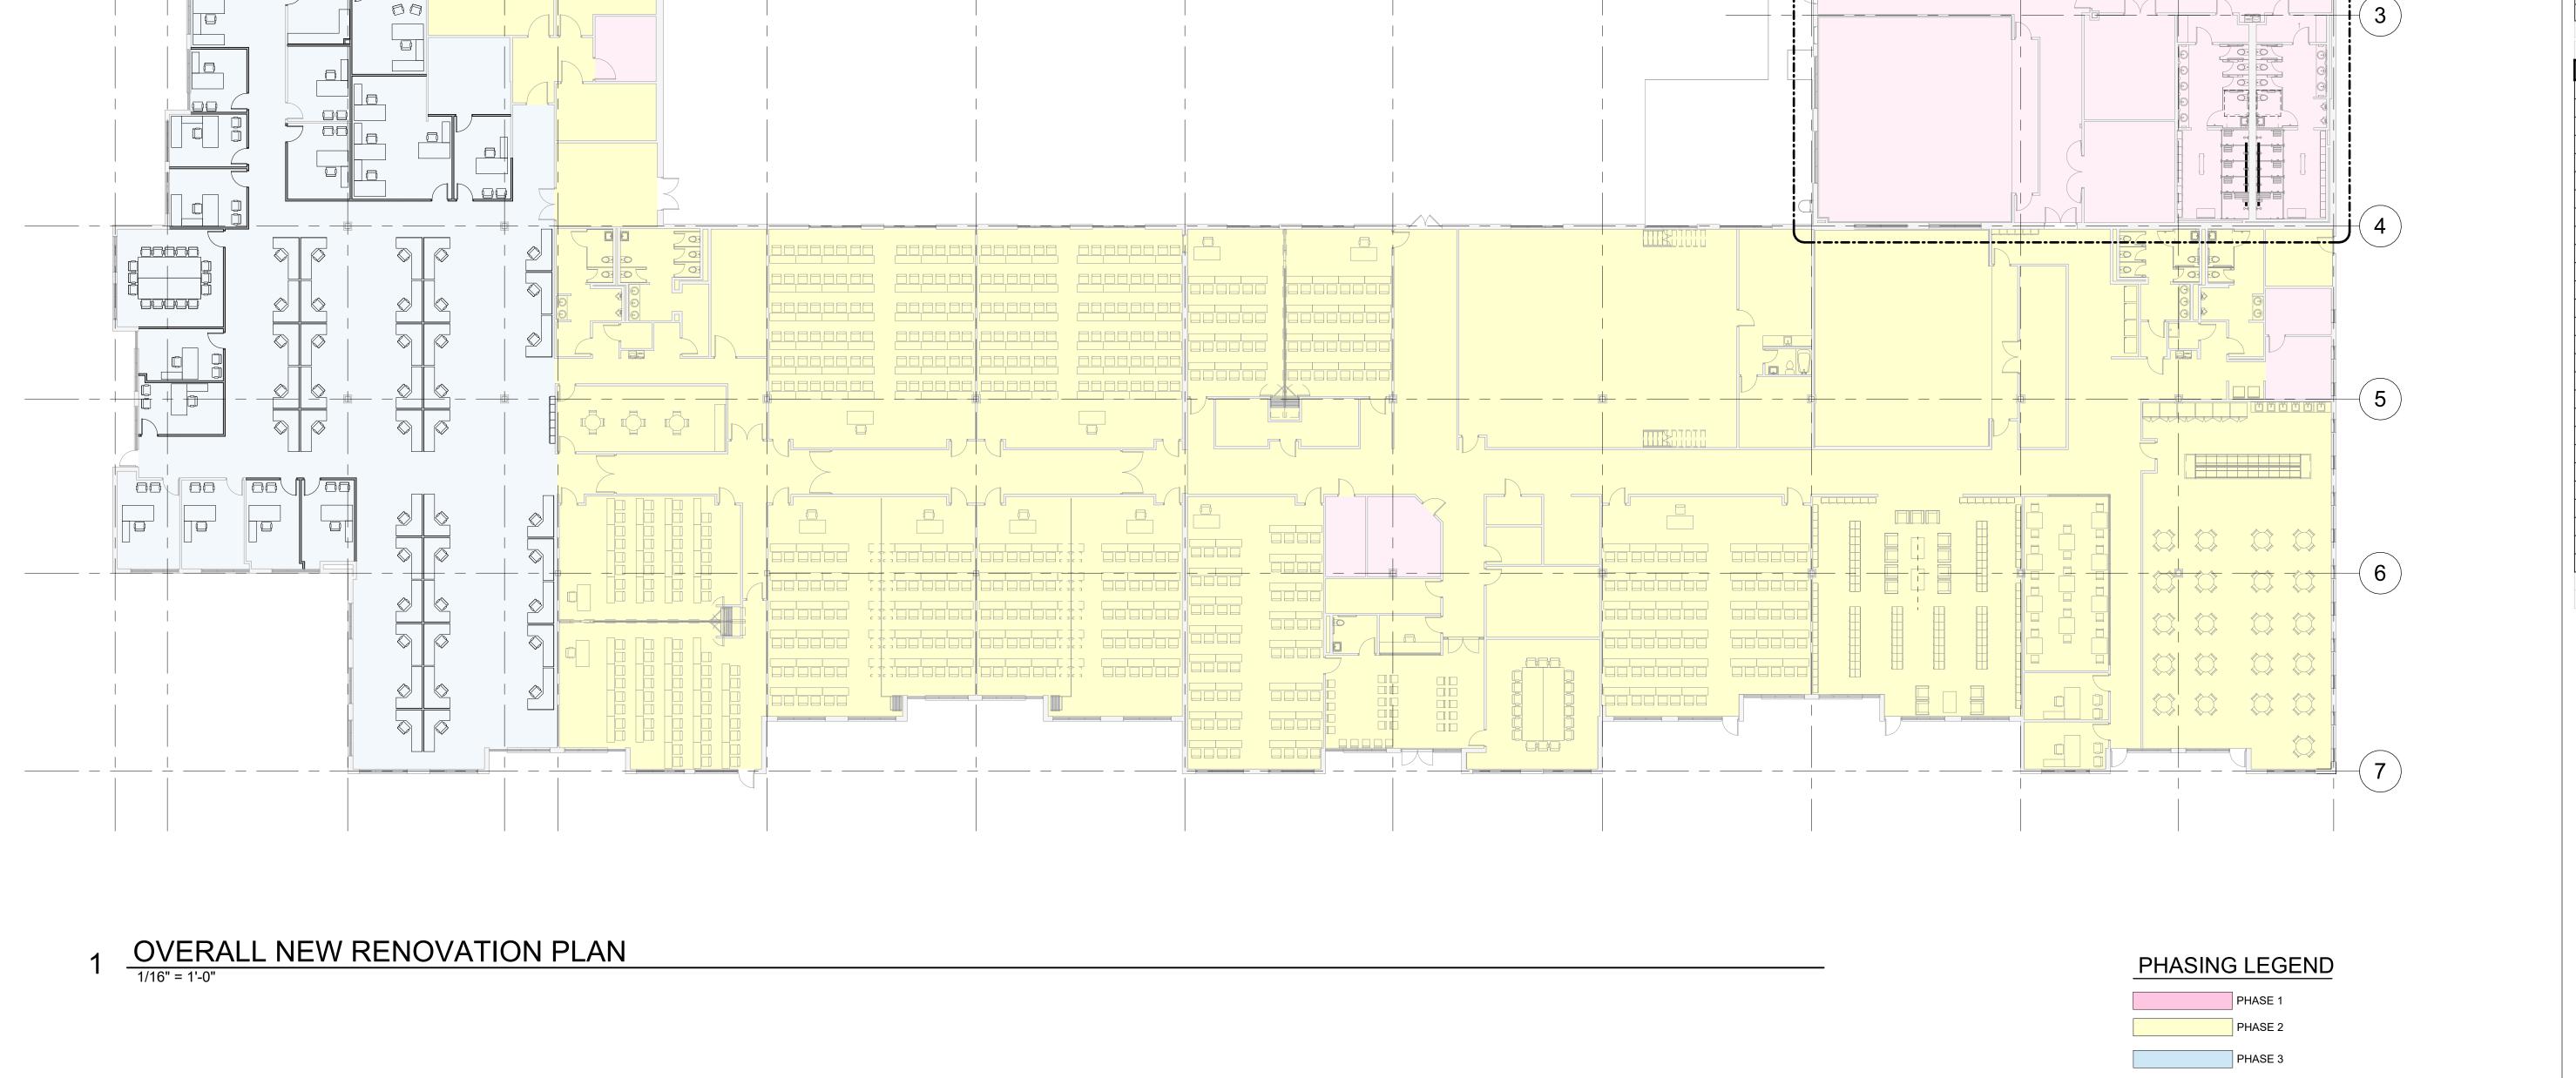


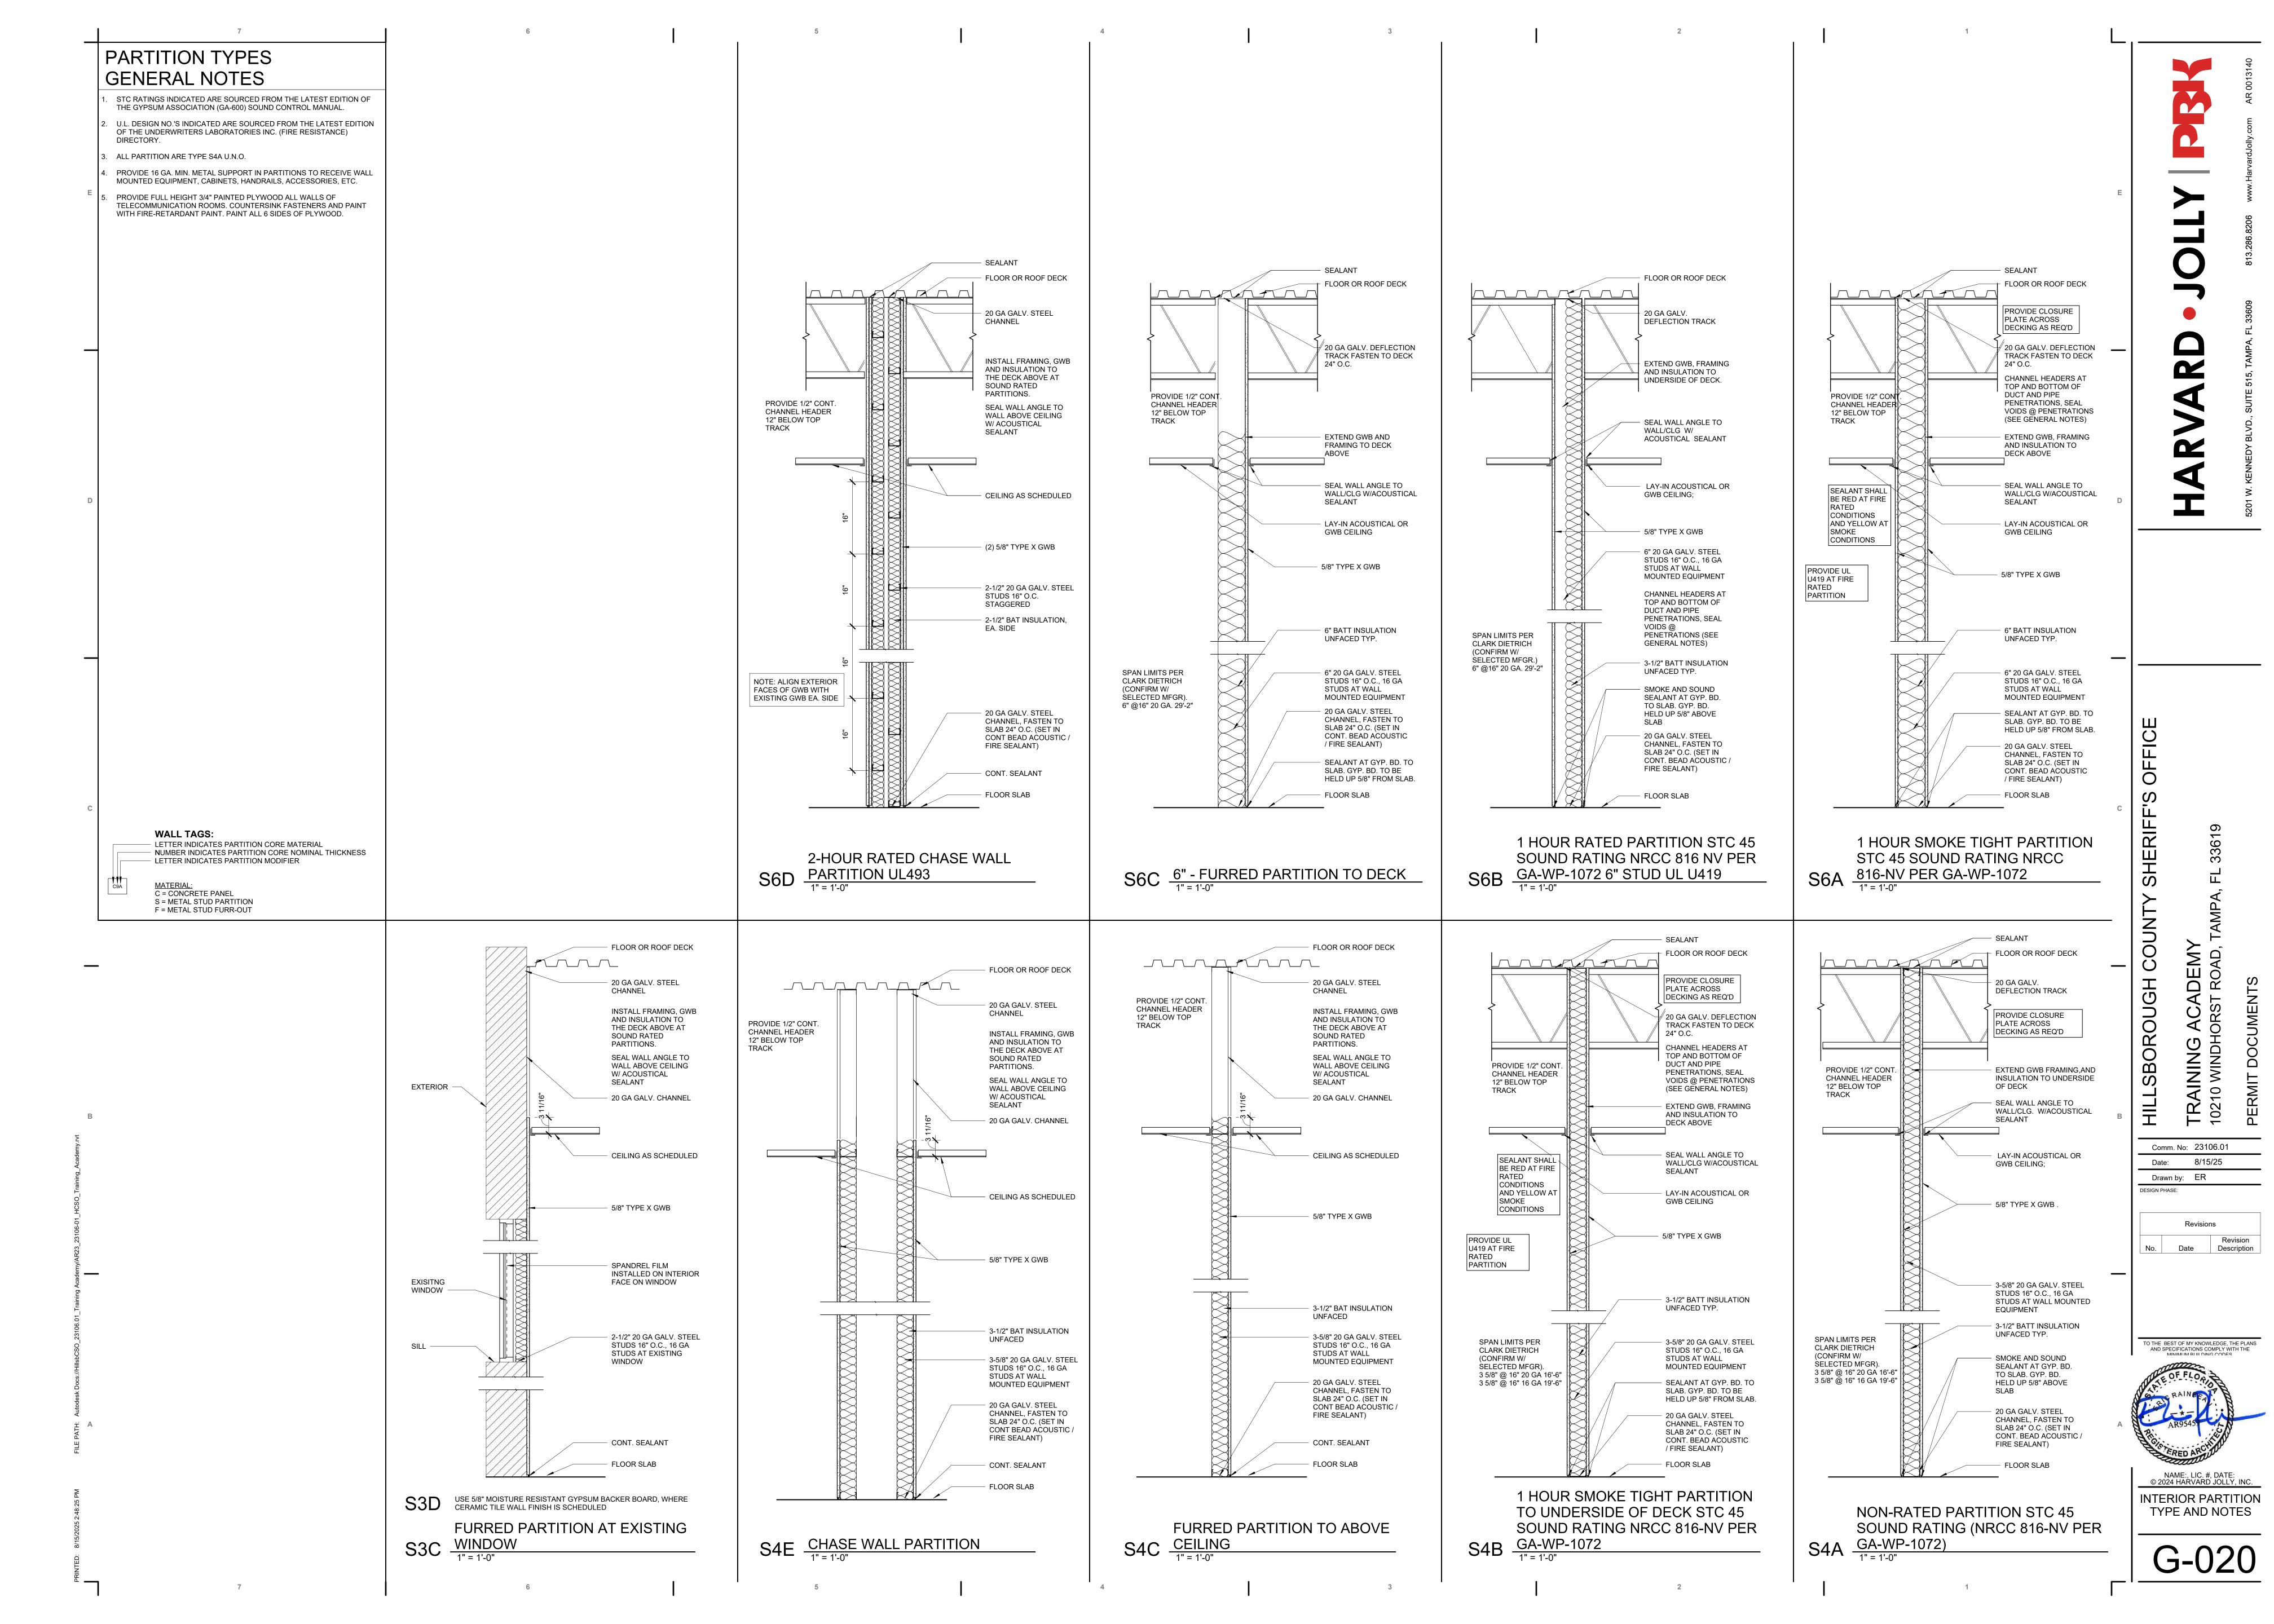


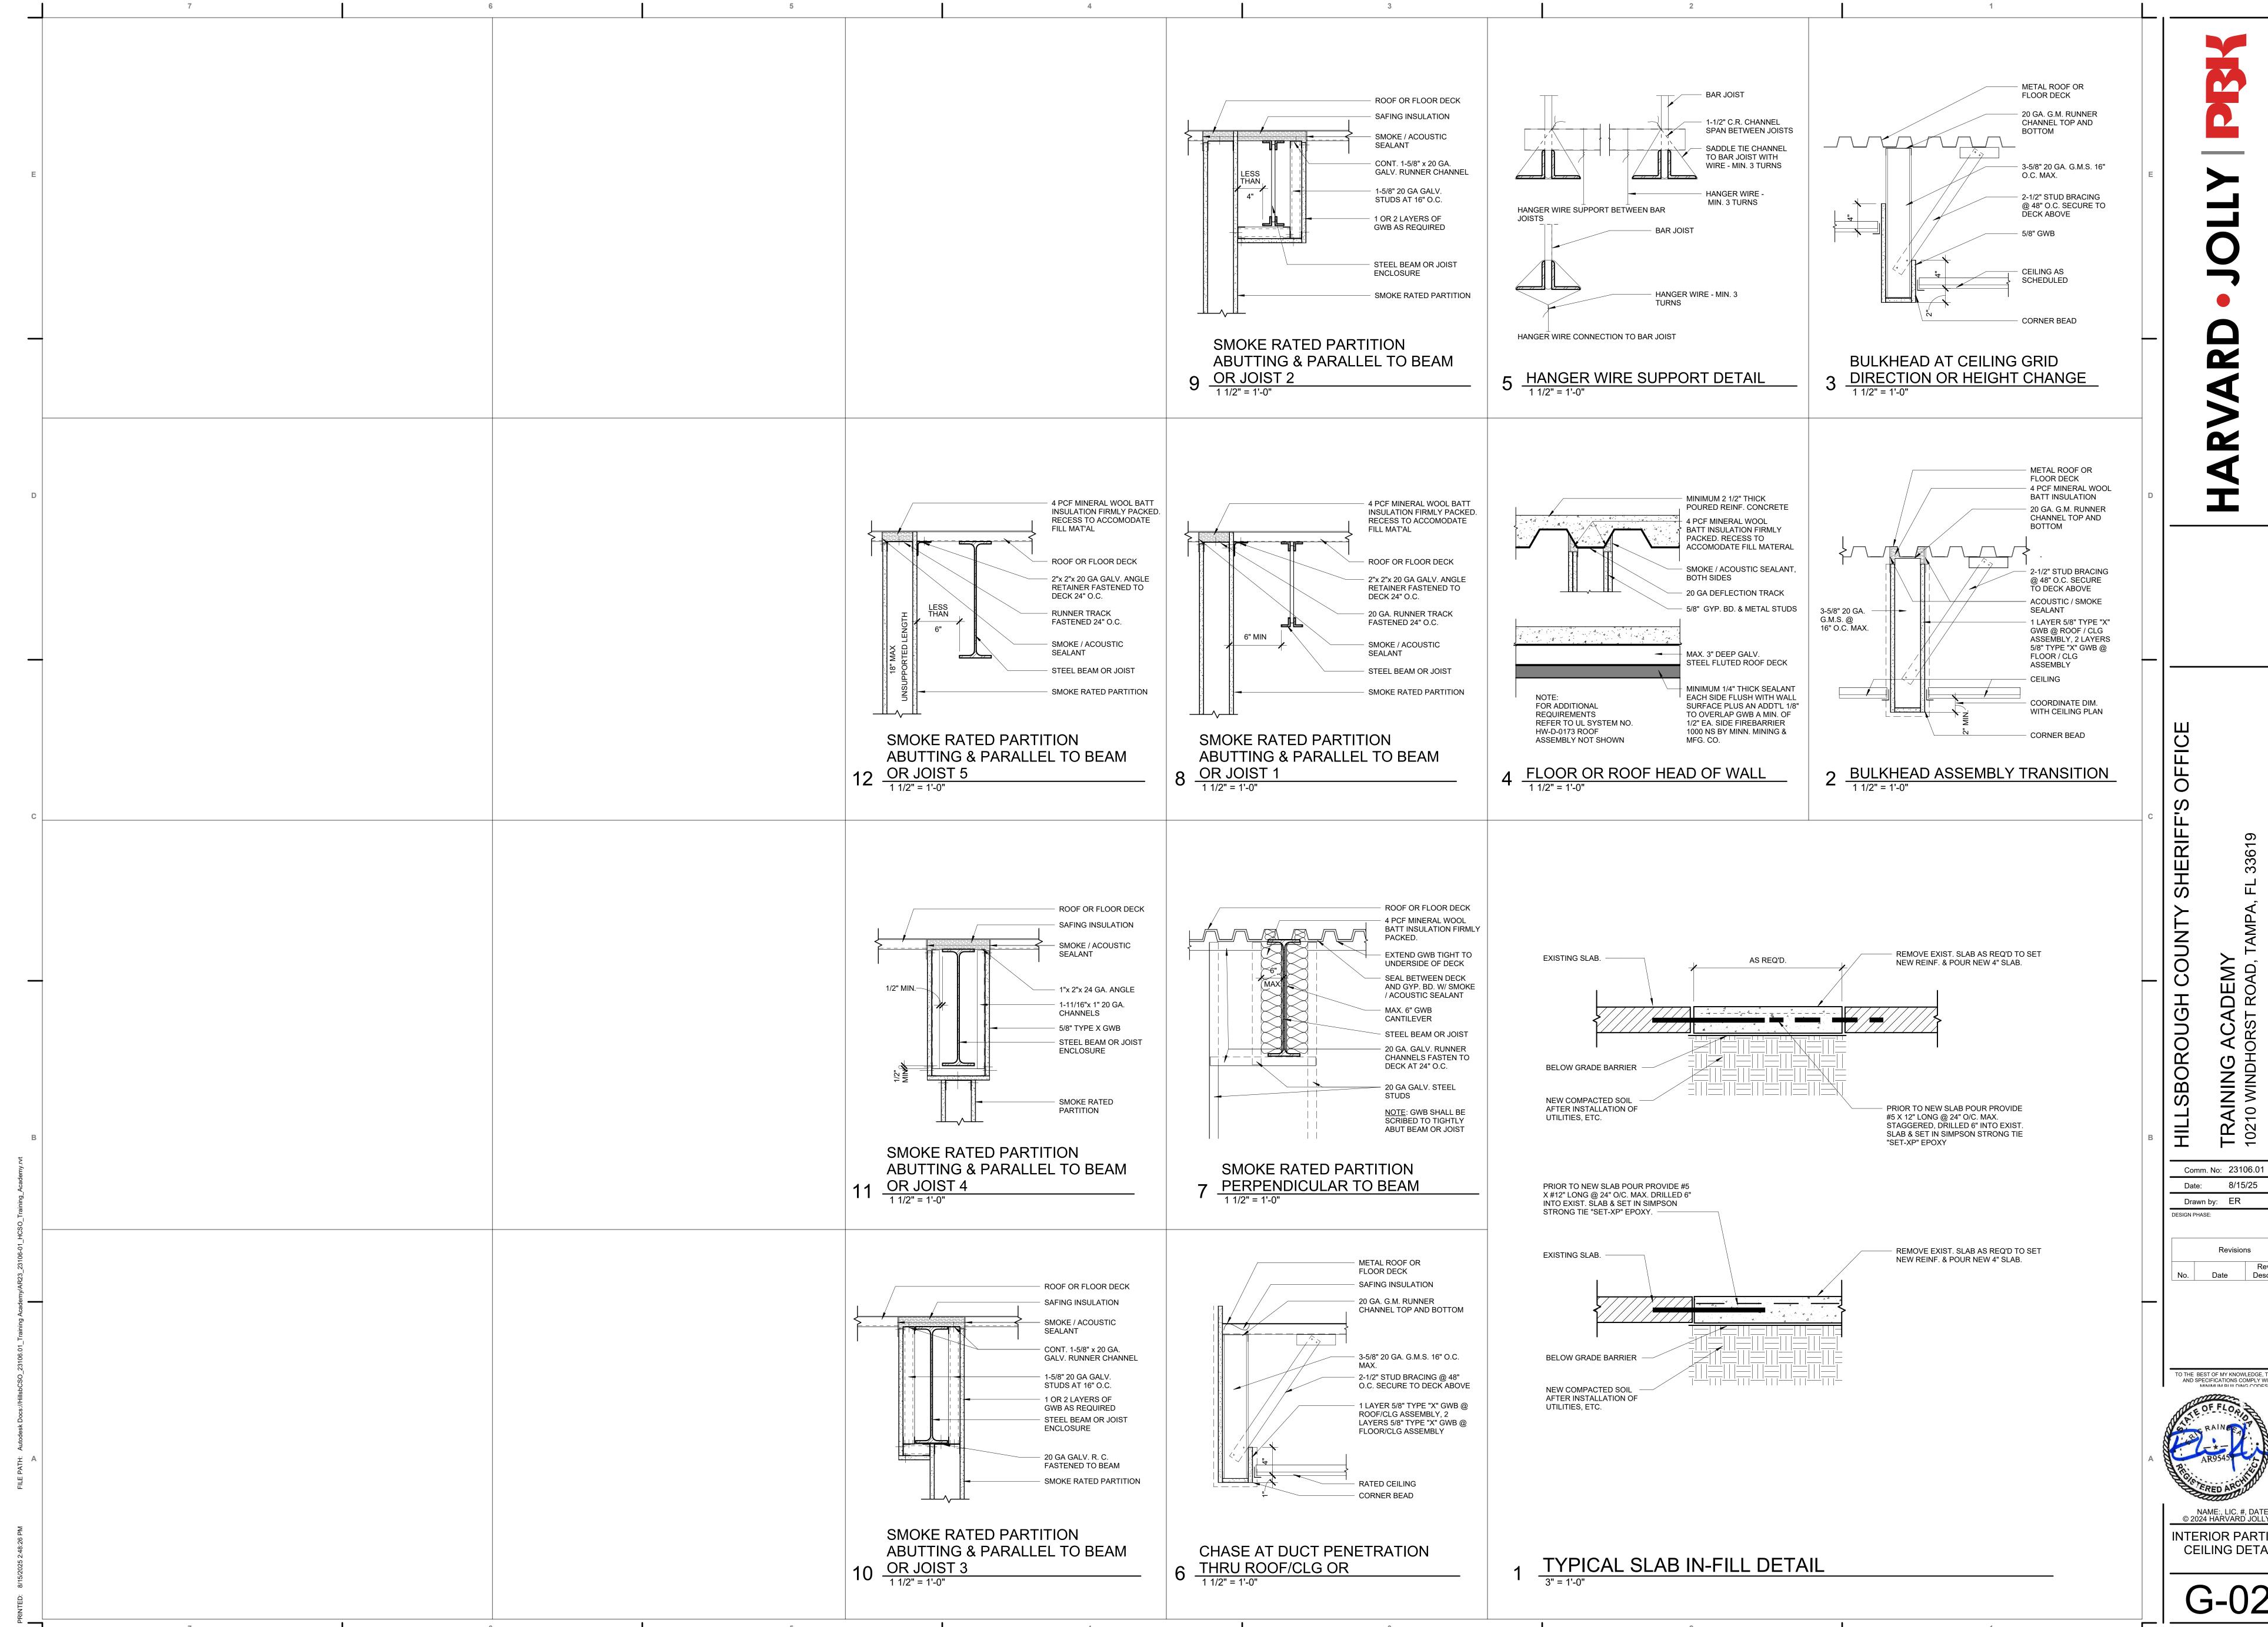

ACADEMY HORST ROAD, 1 TRAINING 10210 WINDH

Drawn by: ER

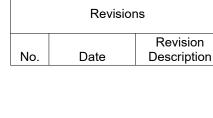

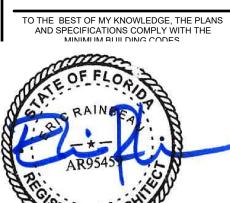

INTERIOR PARTITION **CEILING DETAILS** 

G-021

OVERALL DEMOLITION PLAN - PHASE 1

**DEMOLITION NOTES** 

SITE VISIT - PRIOR TO STARTING WORK, CONTRACTOR SHALL VISIT THE PROJECT SITE AND THOROUGHLY BECOME FAMILIAR WITH EXISTING CONDITIONS. NO CLAIMS FOR ADDITIONAL WORK DUE TO OBSERVABLE CONDITIONS WILL BE CONSIDERED. <u>DEMOLITION WORK</u> - CARRY OUT DEMOLITION WORK TO CAUSE AS LITTLE INCONVENIENCE TO ADJACENT OCCUPIED BUILDING AREAS. DEMOLISH IN AN ORDERLY AND CAREFUL MANNER AS REQUIRED TO ACCOMMODATE NEW WORK. PERFORM DEMOLITION IN ACCORDANCE WITH APPLICABLE AUTHORITIES HAVING JURISDICTION. TAKE CARE TO PREVENT DAMAGE AND EXCESSIVE NOISE OR VIBRATION SO AS TO NOT DISTURB ADJACENT OCCUPIED AREAS. ANY OPERATION THAT MAY CAUSE DISTURBANCE TO OWNER'S FUNCTIONING OPERATION OF THE PROJECT SHALL BE COORDINATED WITH THE OWNER AT A MUTUALLY AGREED UPON REGULAR ADVANCED TIMELINE OR AS SPECIFIED. SOME WORK MAY REQUIRE 'OFF HOURS' FROM OWNER OCCUPIED AREAS TO ALLOW FOR OWNER'S NORMAL OPERATIONAL HOURS' USE. SCHEDULING - SCHEDULE DEMOLITION WORK WITH FACILITY ADMINISTRATION/ OWNER PRIOR TO START OF THE WORK TO

OPERATIONAL HOURS USE.

SCHEDULING - SCHEDULE DEMOLITION WORK WITH FACILITY
ADMINISTRATION/ OWNER PRIOR TO START OF THE WORK TO
MINIMIZE DISRUPTION OF SERVICES AND PROVIDE FOR THE
UNINTERRUPTED FUNCTIONING OF THE FACILITY AS
APPLICABLE.
PROTECTION - EXERCISE CARE DURING WORK TO PROTECT

EXISTING ELEMENTS AND SYSTEMS. REPAIR TO EXISTING
CONSTRUCTION DUE TO DAMAGE CAUSED BY PERFORMING THE
WORK SHALL BE PERFORMED AT NO COST TO THE OWNER.
HAZARDOUS MATERIALS - THE CONTRACTOR SHALL
IMMEDIATELY REPORT ANY HAZARDOUS OR TOXIC MATERIALS
DISCOVERED TO ARCHITECT, OWNER, AND AUTHORITIES
HAVING JURISDICTION.
WHERE OPENINGS ARE CREATED IN EXISTING CONSTRUCTION

HAVING JURISDICTION.
WHERE OPENINGS ARE CREATED IN EXISTING CONSTRUCTION
TO REMAIN, VISIBLE EDGES OF THE OPENING SHALL BE
FINISHED TO A MATCHING CONDITION OF SIMILAR EXISTING
OPENINGS IN THE AREA OF WORK.
WHERE DOORS OR WINDOWS OR SYSTEMS IN AN EXISTING
OPENING ARE REMOVED, REMOVE ALL NON STRUCTURALLY
ELEMENTS SUCH THAT WILL ALLOW FOR REQUIRED INFILL
WALLS ALIGNED TO BE FINISHED AND MATCHED FLUSH ON

BOTH VISIBLE SIDES OF ADJACENT WALLS U.O.N.

WHERE EXISTING MECHANICAL, PLUMBING, ELECTRICAL, FIRE PROTECTION, AND MED GAS SYSTEMS ARE AFFECTED BY DEMOLITION WORK, THE SERVICES SHALL BE REMOVED TO A POINT WHERE THEY CAN BE CAPPED AND TERMINATED U.O.N.

WHERE NEW FINISHES ARE SCHEDULED FOR EXISTING OR RENOVATED SPACES, REMOVE EXISTING FINISHES AND PREPARE SUBSTRATES AS REQUIRED TO RECEIVE NEW FINISHES AS SCHEDULED. PREPARATION INCLUDES BUT IS NOT LIMITED TO: PATCHING AND/ OR LEVELING OF FLOORS, SKIM COATING OF GYPSUM AND PLASTER SURFACES, SANDING OF

NON-PRE-FINISHED METALS. CUTTING AND PATCHING REQUIRED FOR THE INSTALLATION OF WORK OF OTHER TRADES SHALL BE PROVIDED AT NO ADDITIONAL COST TO THE OWNER. REFER TO MECHANICAL, PLUMBING, ELECTRICAL, FIRE PROTECTION, AND MEDICAL GAS DRAWINGS AS APPLICABLE. SUCH CUTTING AND PATCHING INCLUDES BUT IS NOT LIMITED TO ROOF PENETRATIONS AND FLASHINGS, CEILING REMOVAL AND REPLACEMENT, DRYWALL AND MASONRY PARTITIONS, CONCRETE FLOORS ETC. WHERE DEMOLITION WOULD AFFECT THE STRUCTURAL INTEGRITY OF THE BUILDING, PROVIDE TEMPORARY SUPPORTS. CONTRACTOR SHALL NOTIFY ARCHITECT OF ANY FOUND CONDITION WHICH WOULD REPRESENT A HAZARDOUS CONDITION TO THE STRUCTURE OR ITS OCCUPANTS BEFORE PROCEEDING. DO NOT PERFORM STRUCTURAL DEMOLITION UNTIL APPROVED MEANS OF SUPPORTS IS INSTALLED. REMOVE AND REINSTALL EXISTING CEILING GRID AS REQUIRED FOR INSTALLATION OF NEW MECHANICAL, ELECTRICAL, FIRE PROTECTION AND PLUMBING EXISTING FIXTURES - EXISTING FIXTURES SHALL BE UTILIZED WHERE SHOWN. CLEAN FIXTURES

POR INSTALLATION OF NEW MECHANICAL, ELECTRICAL, FIRE PROTECTION AND PLUMBING EXISTING FIXTURES - EXISTING FIXTURES SHALL BE UTILIZED WHERE SHOWN. CLEAN FIXTURES PRIOR TO REINSTALLATION. REMAINING EXISTING FIXTURES NOT RE-USED AND IN WORKING CONDITION SHALL BE TURNED OVER TO THE OWNER.

13. REMOVE ALL EXISTING ACT AND GYP. BOARD CEILING SYSTEMS IN ENTIRETY. WHERE EXISTING CEILINGS ARE REMOVED, TAKE CARE TO REMOVE ONLY THAT PORTION SO INDICATED TO BE REMOVED.

14. FOR AREAS WHERE WORK REQUIRES ACCESS ABOVE THE

CEILING. IN THESE AREAS REMOVE AND REPLACE THE CEILING
AS NECESSARY FOR ACCESS TO WORK. MATCH EXISTING
CEILING AND FINISHES UPON COMPLETION OF WORK IN THESE
AREAS.

15. FLOORS - REMOVE ALL FLOORING DOWN TO ORIGINAL
CONCRETE SLAB AND CONTRACTOR SHALL FIELD VERIFY
LEVELNESS OF EXISTING FLOOR SLABS AFTER COMPLETION OF
DEMOLITION WORK AND BRING TO THE ARCHITECT'S ATTENTION
ANY DEVIATION FROM SPECIFIED TOLERANCES. ANY
CORRECTIVE WORK SHALL BE ACCOMPLISHED PRIOR TO NEW

CONSTRUCTION.

<u>EQUIPMENT COORDINATION</u> - CONTRACTOR SHALL BE
RESPONSIBLE FOR PROTECTION OF ALL EXISTING FINISHES,
FURNITURE, AND EQUIPMENT TO REMAIN IN AREAS WHERE
CONSTRUCTION FOR THIS PROJECT OCCURS. OWNER AND
CONTRACTOR SHALL COORDINATE PRIOR TO CONSTRUCTION
FOR ANY SYSTEM/ DEVICE/ EQUIPMENT THE OWNER PREFERS
TO MOVE INCLUDING ITS STORAGE REQUIREMENTS.

<u>DEMOLITION NOTES</u> - NUMBERED NOTES BELOW ARE
SUMMARIZED FOR SYSTEMS TO BE DEMOLISHED. THESE ARE
NOT CONSIDERED TO BE ALL-INCLUSIVE OR COMPLETE IN OF
THEMSELVES. PERFORM ADDITIONAL DEMOLITION THAT MIGHT
REASONABLY BE REQUIRED FOR PREPARATION OF INSTALLING
NEW WORK AND SPECIFIED FINISHES.

**KEY PLAN** 

HILLSBOROUGH COUNTY SHERIFF'S OFF


Comm. No: 23106.01

Date: 8/15/25

Drawn by: ER

Revisions
Revision
Date Description

TO THE BEST OF MY KNOWLEDGE, THE PLANS AND SPECIFICATIONS COMPLY WITH THE MINIMI IM BUILDING CODES

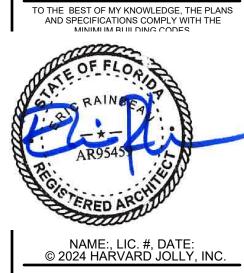

ARCHITECTURAL DEMOLITION PLAN

AD-100



SITE VISIT - PRIOR TO STARTING WORK, CONTRACTOR SHALL VISIT THE PROJECT SITE AND THOROUGHLY BECOME FAMILIAR WITH EXISTING CONDITIONS. NO CLAIMS FOR ADDITIONAL WORK DUE TO OBSERVABLE CONDITIONS WILL BE CONSIDERED. <u>DEMOLITION WORK</u> - CARRY OUT DEMOLITION WORK TO CAUSE AS LITTLE INCONVENIENCE TO ADJACENT OCCUPIED BUILDING AREAS. DEMOLISH IN AN ORDERLY AND CAREFUL MANNER AS REQUIRED TO ACCOMMODATE NEW WORK. PERFORM DEMOLITION IN ACCORDANCE WITH APPLICABLE AUTHORITIES HAVING JURISDICTION. TAKE CARE TO PREVENT DAMAGE AND EXCESSIVE NOISE OR VIBRATION SO AS TO NOT DISTURB ADJACENT OCCUPIED AREAS. ANY OPERATION THAT MAY CAUSE DISTURBANCE TO OWNER'S FUNCTIONING OPERATION OF THE PROJECT SHALL BE COORDINATED WITH THE OWNER AT A MUTUALLY AGREED UPON REGULAR ADVANCED TIMELINE OR AS SPECIFIED. SOME WORK MAY REQUIRE 'OFF HOURS' FROM OWNER OCCUPIED AREAS TO ALLOW FOR OWNER'S NORMAL OPERATIONAL HOURS' USE. SCHEDULING - SCHEDULE DEMOLITION WORK WITH FACILITY ADMINISTRATION/ OWNER PRIOR TO START OF THE WORK TO MINIMIZE DISRUPTION OF SERVICES AND PROVIDE FOR THE UNINTERRUPTED FUNCTIONING OF THE FACILITY AS

PROTECTION - EXERCISE CARE DURING WORK TO PROTECT EXISTING ELEMENTS AND SYSTEMS. REPAIR TO EXISTING CONSTRUCTION DUE TO DAMAGE CAUSED BY PERFORMING THE WORK SHALL BE PERFORMED AT NO COST TO THE OWNER. HAZARDOUS MATERIALS - THE CONTRACTOR SHALL IMMEDIATELY REPORT ANY HAZARDOUS OR TOXIC MATERIALS DISCOVERED TO ARCHITECT, OWNER, AND AUTHORITIES HAVING JURISDICTION. WHERE OPENINGS ARE CREATED IN EXISTING CONSTRUCTION TO REMAIN, VISIBLE EDGES OF THE OPENING SHALL BE FINISHED TO A MATCHING CONDITION OF SIMILAR EXISTING OPENINGS IN THE AREA OF WORK. WHERE DOORS OR WINDOWS OR SYSTEMS IN AN EXISTING

OPENING ARE REMOVED, REMOVE ALL NON STRUCTURALLY ELEMENTS SUCH THAT WILL ALLOW FOR REQUIRED INFILL WALLS ALIGNED TO BE FINISHED AND MATCHED FLUSH ON BOTH VISIBLE SIDES OF ADJACENT WALLS U.O.N. WHERE EXISTING MECHANICAL, PLUMBING, ELECTRICAL, FIRE PROTECTION, AND MED GAS SYSTEMS ARE AFFECTED BY DEMOLITION WORK, THE SERVICES SHALL BE REMOVED TO A POINT WHERE THEY CAN BE CAPPED AND TERMINATED U.O.N. WHERE NEW FINISHES ARE SCHEDULED FOR EXISTING OR RENOVATED SPACES, REMOVE EXISTING FINISHES AND PREPARE SUBSTRATES AS REQUIRED TO RECEIVE NEW FINISHES AS SCHEDULED. PREPARATION INCLUDES BUT IS NOT LIMITED TO: PATCHING AND/ OR LEVELING OF FLOORS, SKIM COATING OF GYPSUM AND PLASTER SURFACES, SANDING OF NON-PRE-FINISHED METALS. CUTTING AND PATCHING REQUIRED FOR THE INSTALLATION OF WORK OF OTHER TRADES SHALL BE PROVIDED AT NO ADDITIONAL COST TO THE OWNER. REFER TO MECHANICAL,

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REMOVE ALL EXISTING ACT AND GYP. BOARD CEILING SYSTEMS IN ENTIRETY. WHERE EXISTING CEILINGS ARE REMOVED, TAKE CARE TO REMOVE ONLY THAT PORTION SO INDICATED TO BE FOR AREAS WHERE WORK REQUIRES ACCESS ABOVE THE CEILING. IN THESE AREAS REMOVE AND REPLACE THE CEILING AS NECESSARY FOR ACCESS TO WORK, MATCH EXISTING

FLOORS - REMOVE ALL FLOORING DOWN TO ORIGINAL CONCRETE SLAB AND CONTRACTOR SHALL FIELD VERIFY LEVELNESS OF EXISTING FLOOR SLABS AFTER COMPLETION OF DEMOLITION WORK AND BRING TO THE ARCHITECT'S ATTENTION ANY DEVIATION FROM SPECIFIED TOLERANCES. ANY CORRECTIVE WORK SHALL BE ACCOMPLISHED PRIOR TO NEW CONSTRUCTION. **EQUIPMENT COORDINATION** - CONTRACTOR SHALL BE RESPONSIBLE FOR PROTECTION OF ALL EXISTING FINISHES, FURNITURE, AND EQUIPMENT TO REMAIN IN AREAS WHERE

CONTRACTOR SHALL COORDINATE PRIOR TO CONSTRUCTION FOR ANY SYSTEM/ DEVICE/ EQUIPMENT THE OWNER PREFERS TO MOVE INCLUDING ITS STORAGE REQUIREMENTS. <u>DEMOLITION NOTES</u> - NUMBERED NOTES BELOW ARE SUMMARIZED FOR SYSTEMS TO BE DEMOLISHED. THESE ARE NOT CONSIDERED TO BE ALL-INCLUSIVE OR COMPLETE IN OF THEMSELVES. PERFORM ADDITIONAL DEMOLITION THAT MIGHT REASONABLY BE REQUIRED FOR PREPARATION OF INSTALLING NEW WORK AND SPECIFIED FINISHES.

## **DEMOLITION DRAWING NOTES:** (#

DEMO EXISTING RESTROOM AND SHOWERS IN ENTIRETY, INCLUDING ALL FIXTURES AND EQUIPMENT. SEE NOTE FOR ADDITIONAL INFORMATION. REMOVE EXISTING GYPSUM BOARD AND FURRING AT REMOVE EXISTING CASEWORK BUILT-IN.

EXISTING ELECTRICAL ROOM TO REMAIN. CLEAN AND SCRAPE EXISTING DOOR, PREP FOR NEW

DEMO WINDOW SYSTEM.

CUT CONC PANEL WALL, COORDINATE OPENING SIZE WITH NEW DOOR CONSTRUCTION. CUT EXISTING RAILING AND STORE FOR REINSTALLATION. SEE CIVIL FOR MORE INFORMATION.

# WALL LEGEND

ITEM TO BE REMOVED \_\_\_\_''' EXISTING TO REMAIN

# **DEMO FLOOR TYPES**

+ + + + + + + + + + + + + + VCT CONCRETE

AREA FOR NEW FINISHES

SLAB REMOVAL

**KEY PLAN** 

ARCHITECTURAL DEMOLITION PLAN

AD-101


DE RO/ Comm. No: 23106.01

Date: 8/15/25 Drawn by: ER

Date

TO THE BEST OF MY KNOWLEDGE, THE PLANS AND SPECIFICATIONS COMPLY WITH THE

NAME:, LIC. #, DATE: © 2024 HARVARD JOLLY, INC.

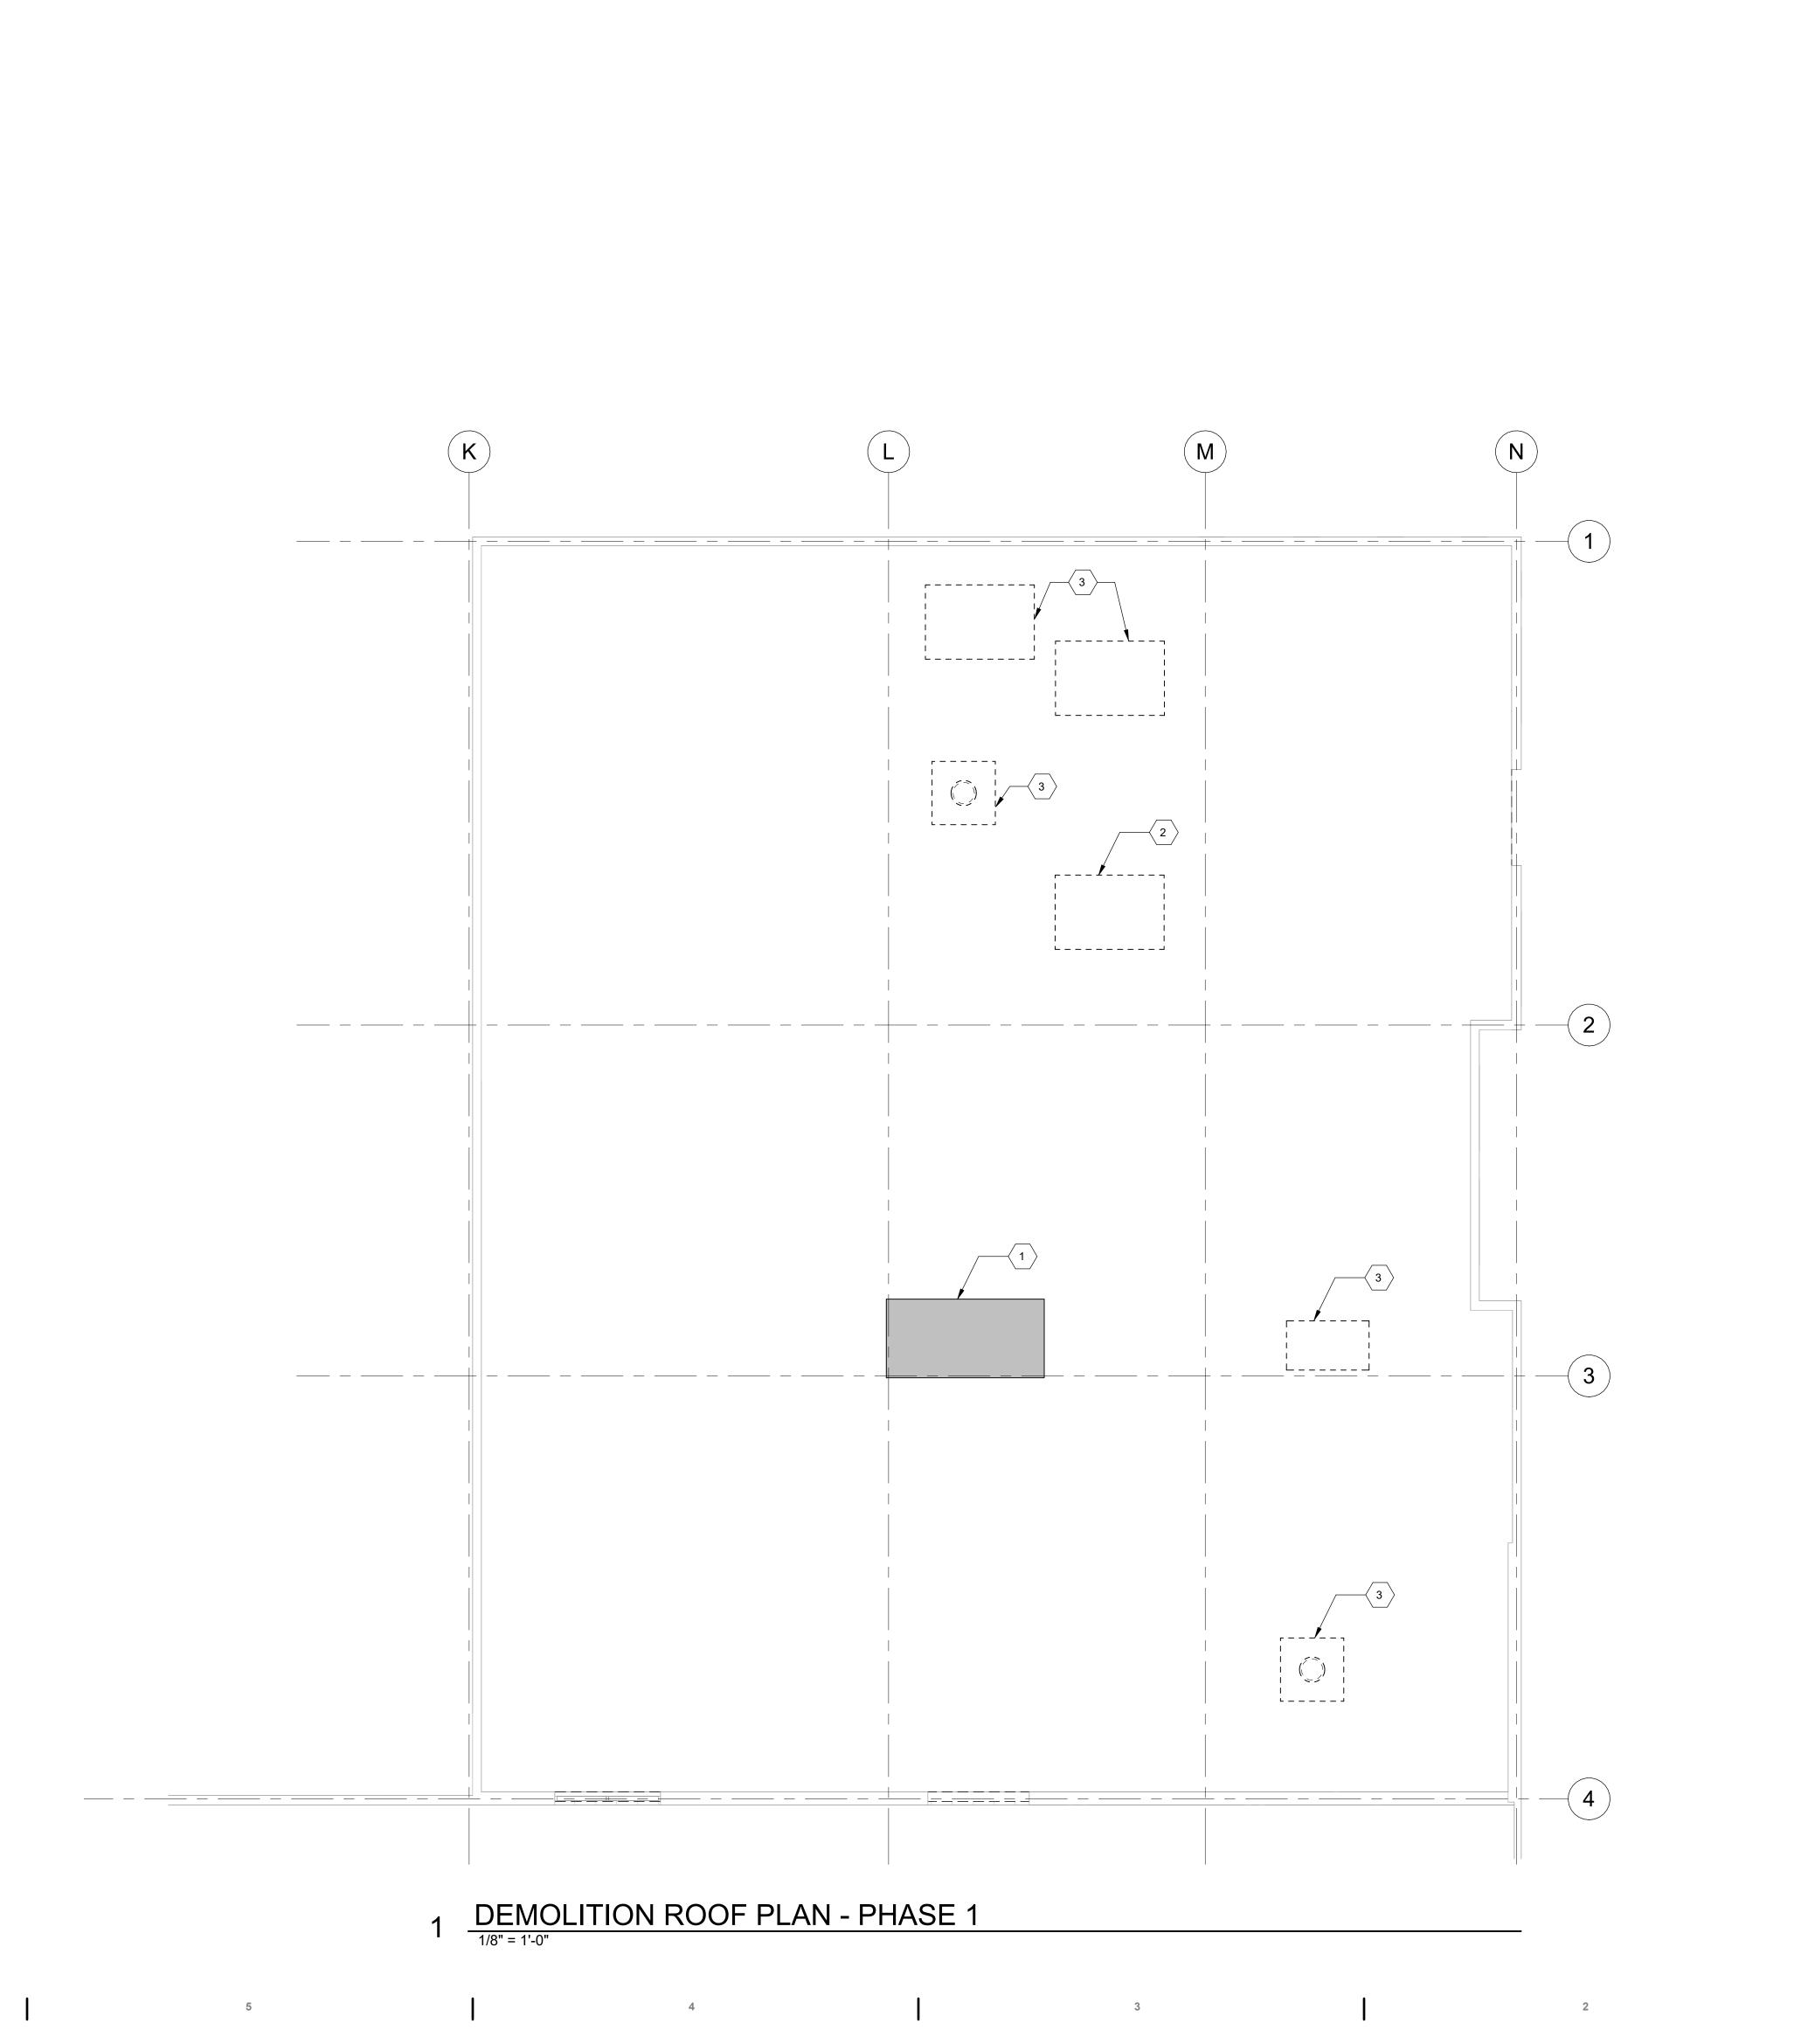

ROOF NOTES: NUMBERED ITEMS (NN)

EXISTING TO REMAIN.
 EXISTING UNIT TO BE REMOVED. PREPARE EXISTING CURB FOR NEW WORK.
 EXISTING TO BE REMOVED

**DEMO LEGEND** 


TO BE REMOVED

TO BE REPLACED

Comm. No: 23106.01

TO THE BEST OF MY KNOWLEDGE, THE PLANS AND SPECIFICATIONS COMPLY WITH THE

DEMOLITION ROOF PLAN

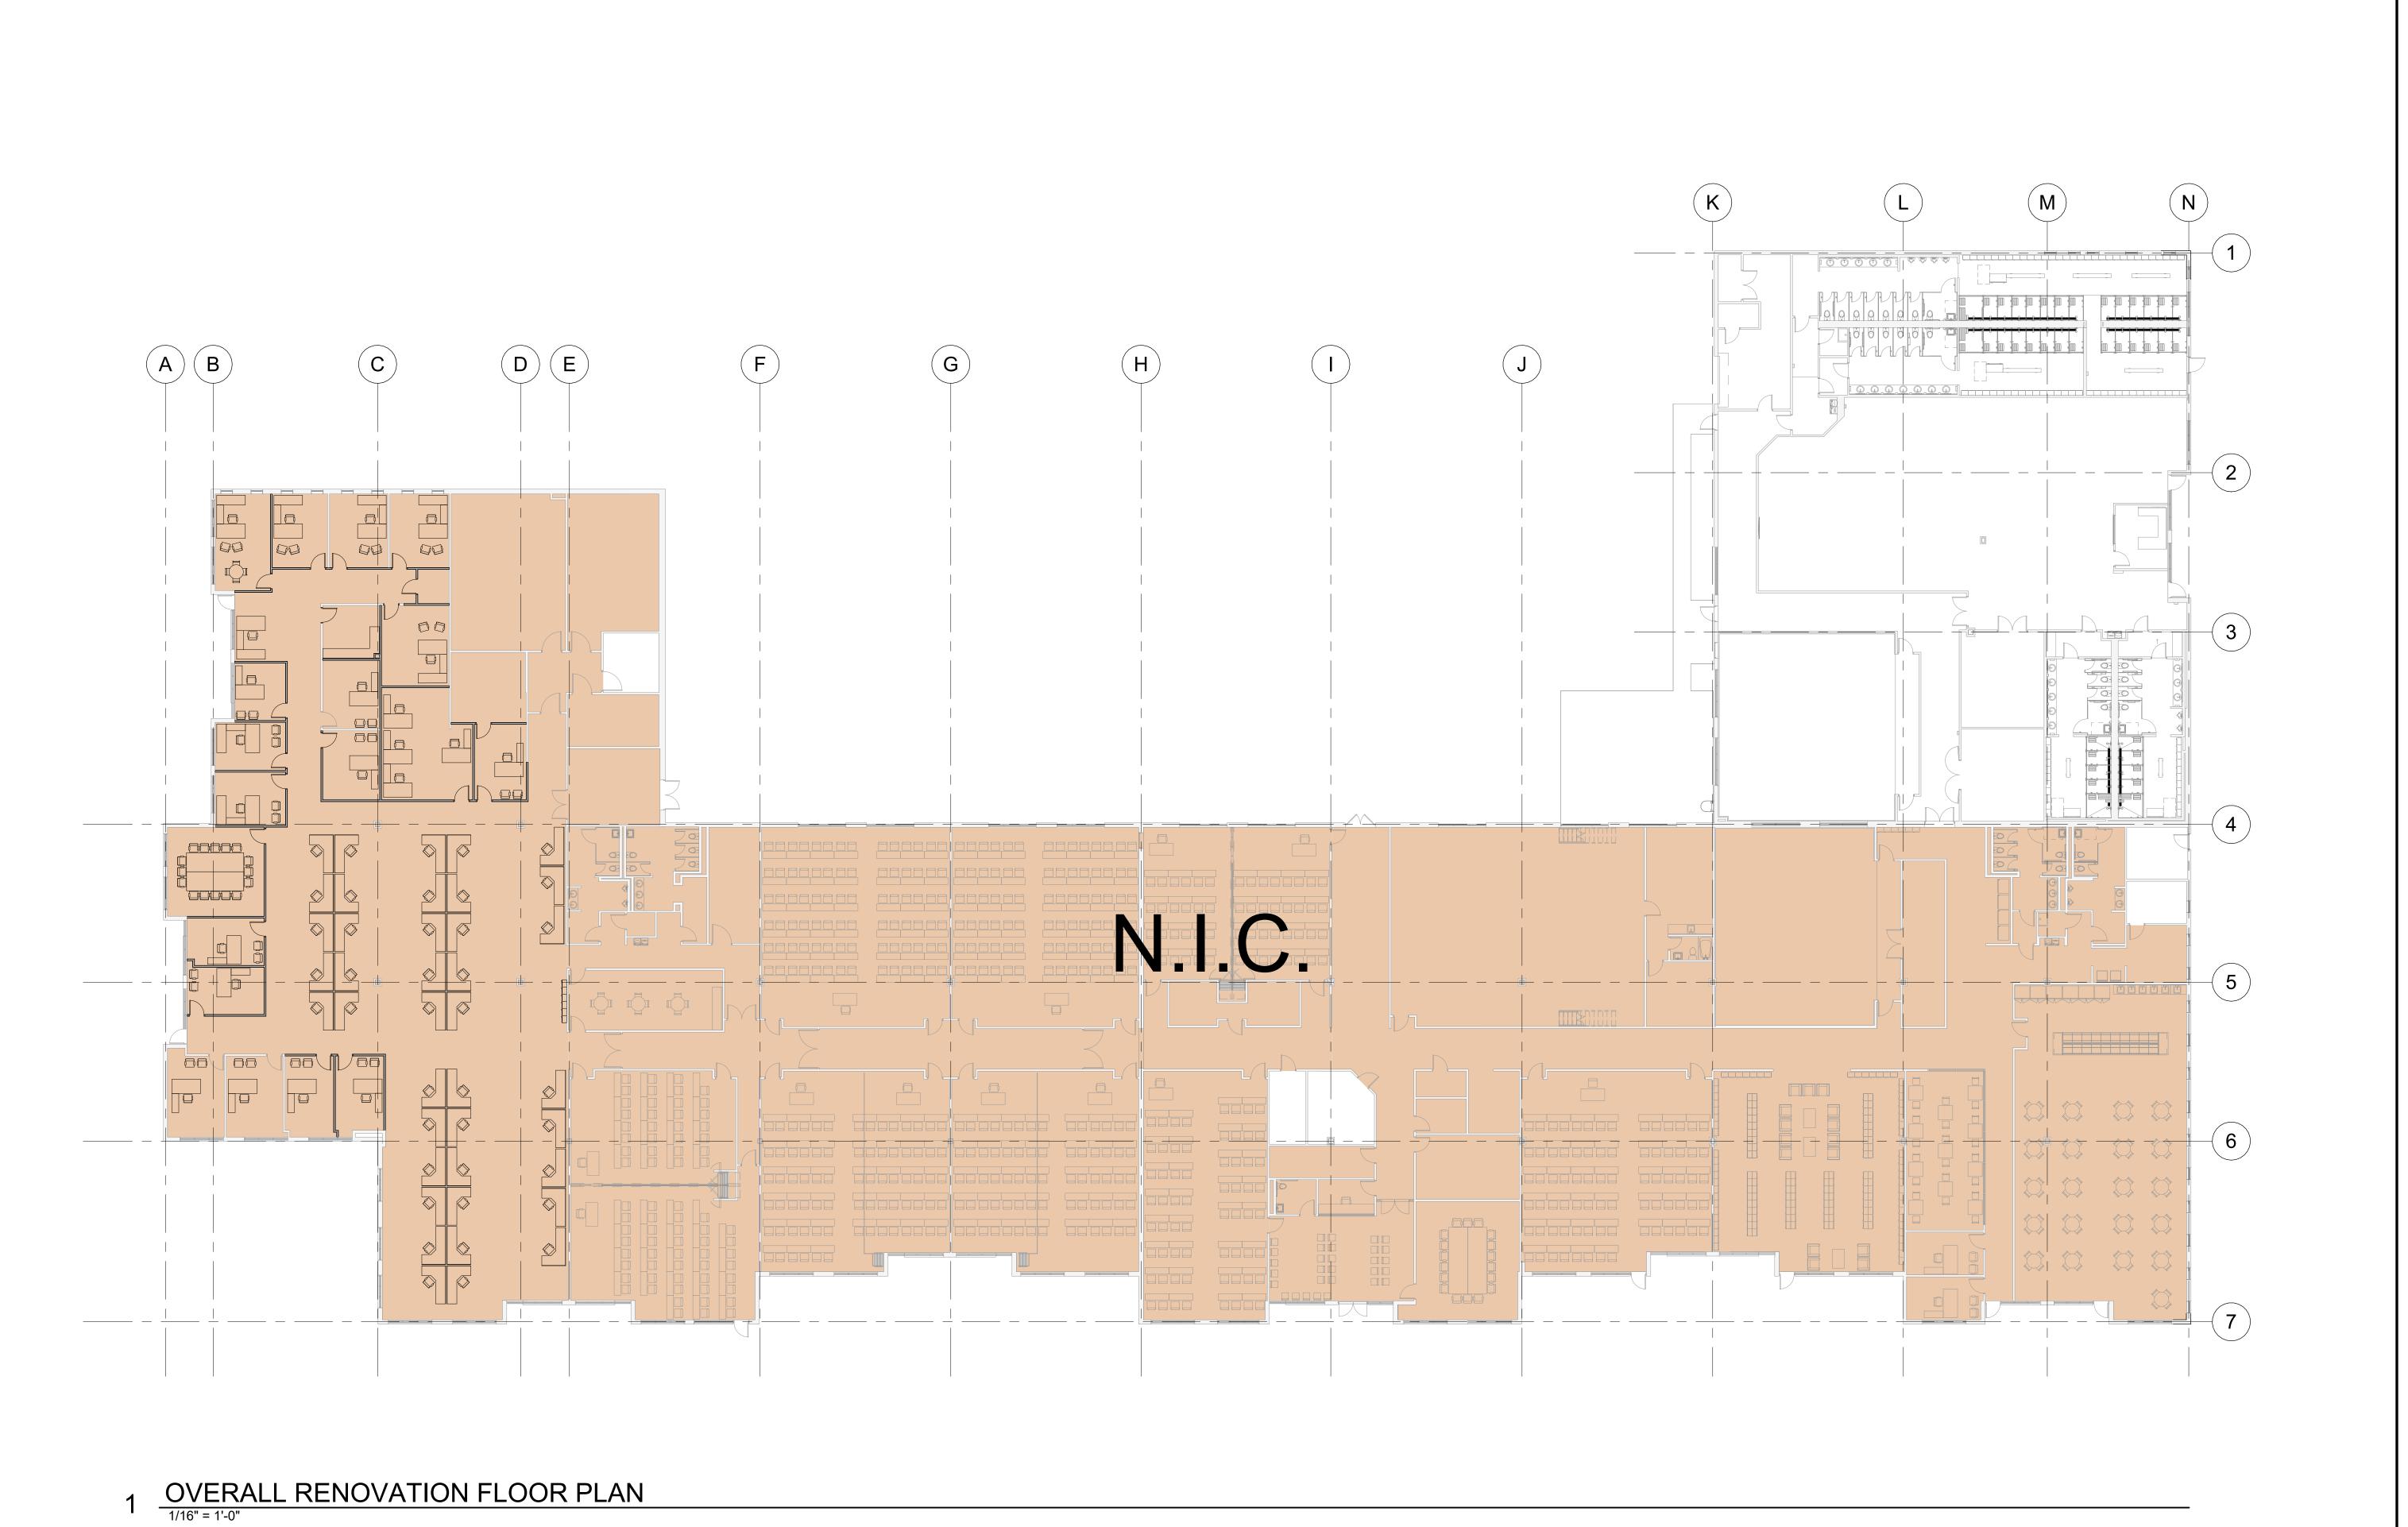

Comm. No: 23106.01 Date: 8/15/25


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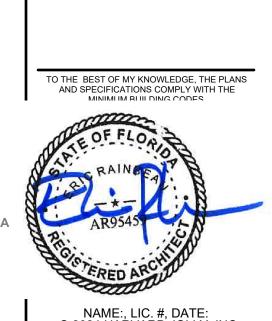
DESIGN PHASE:

GENERAL NOTE:

FUTURE PHASE INFORMATION IS FOR INFORMATIONAL
PURPOSES ONLY AND ARE IS SUBJECT TO CHANGE. WORK IN
FUTURE PHASES WILL BE UNDER SEPARATE PERMIT AND WILL
FOLLOW ALL APPLICABLE CODES AT THE TIME OF PERMIT.

**KEY PLAN** 




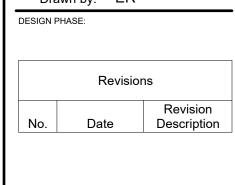

OVERALL RENOVATION PLAN


2 OVERALL LIFE SAFETY PLAN


1/32" = 1'-0"

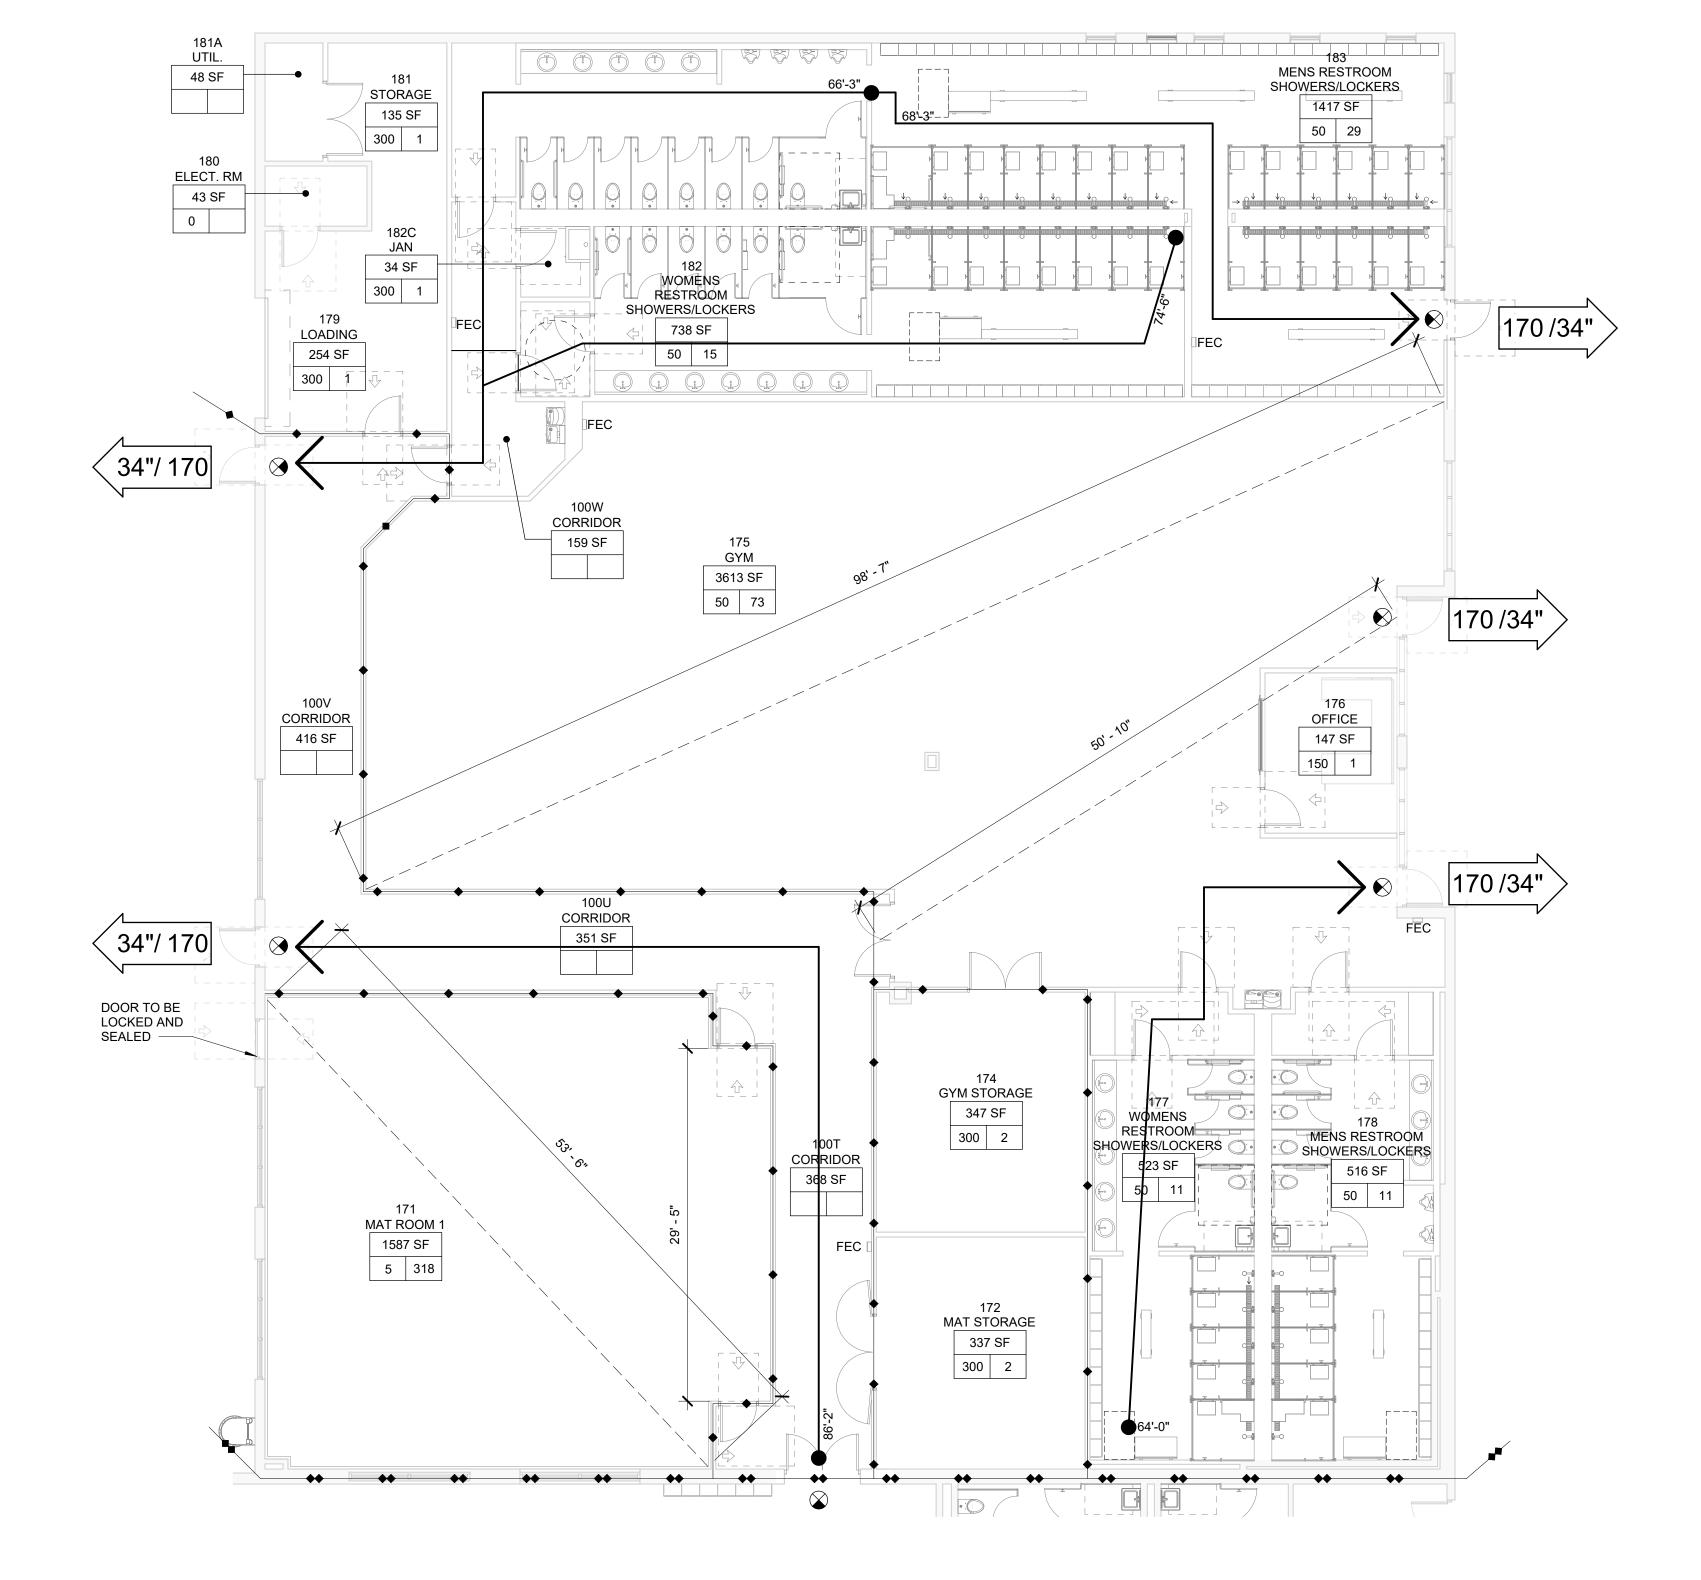

LIFE SAFETY PLAN - PHASE 1

1/8" = 1'-0"

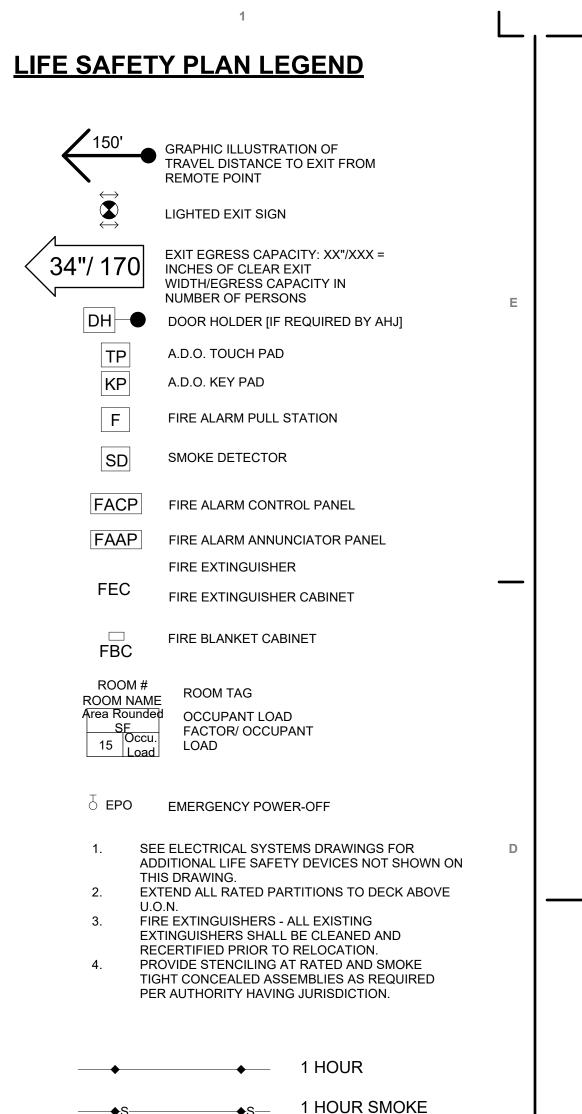


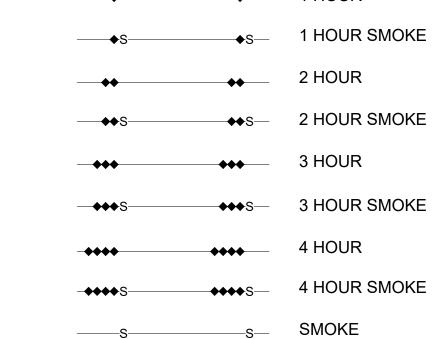


**KEY PLAN** 


HILLSBOROUGH COUNTY ACADEMY HORST ROAD, T

Comm. No: 23106.01 Date: 8/15/25 Drawn by: ER

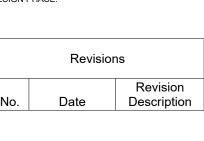

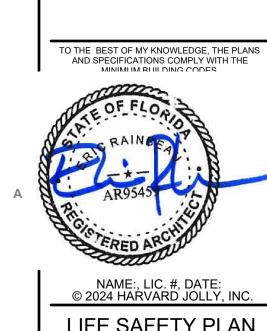



LIFE SAFETY PLAN

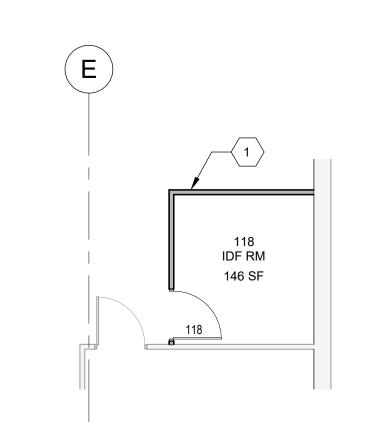

4 IDF ROOM 118

1/8" = 1'-0"

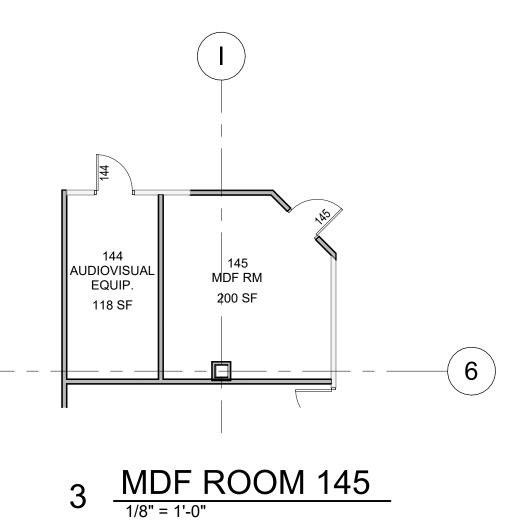

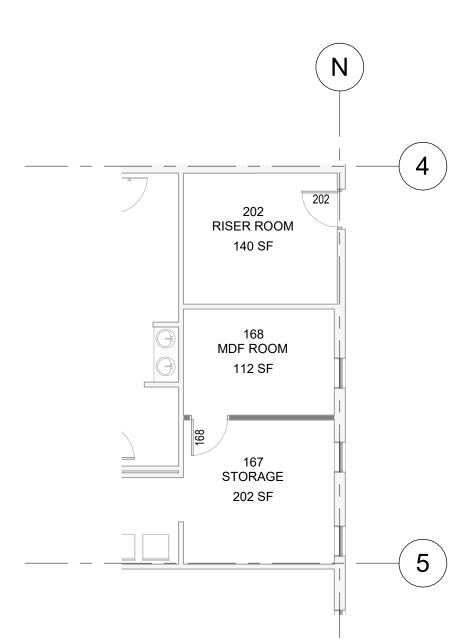

2 MDF ROOM 168

## FLOOR PLAN NOTES:

- FIRE RESISTANCE MAINTAIN INTEGRITY OF EXISTING FIRE AND/OR SMOKE PARTITIONS THROUGHOUT, UNLESS NOTED OTHERWISE. MAINTAIN INTEGRITY OF ALL EXISTING FIREPROOFING, FIRESTOPPING, COLUMN ENCLOSURES, ETC. TO ENSURE FIRE RESISTANCE MEETS OR EXCEEDS THAT ORIGINALLY REQUIRED OR SPECIFIED. PATCH ALL AREAS DAMAGED OR REMOVED DUE TO NEW CONSTRUCTION TO MATCH THAT OF THE EXISTING OR AS REQUIRED FOR NEW. FINISHES - ALL EXISTING FINISHES SHALL REMAIN, UNLESS SCHEDULED FOR NEW. CONTINUE EXISTING FINISHES TO REMAIN INTO NEW EXTENDED AREAS THAT ARE ADJACENT. PATCH & REPAIR EXISTING TO MATCH NEW. PREPARE SUBSTRATES TO RECEIVE NEW FINISHES WHERE SCHEDULED. FINISH ALL PATCHED OR EXTENDED WALLS TO NEAREST CHANGE OF DIRECTION, WALL TERMINATION, OR INTERSECTION PHASING - COORDINATE EQUIPMENT DELIVERIES AND INSTALLATION WITH THE PHASING PLAN
- FOR APPROPRIATE SCHEDULING.

  3. CONFLICTS ANY CONFLICT FOUND WITH EXISTING CONDITIONS AND REQUIREMENTS FOR NEW CONSTRUCTION SHALL BE IMMEDIATELY BROUGHT TO THE ATTENTION OF THE ARCHITECT. IF THE CONFLICT AFFECTS THE PROGRESS OF THE WORK, VERIFY WITH ARCHITECT SOLUTION NECESSARY PRIOR TO PROCEEDING WITH THAT PORTION OF THE WORK AND IN A TIMELY FASHION SO AS NOT TO DELAY THE WORK. COORDINATE ALL TRADES TO ASCERTAIN NO FURTHER WORK WILL BE IMPACTED BY THE CONFLICT, OR ITS SOLUTION.

4. REFER TO FINISH SCHEDULE LEGEND FOR ALL WALL PROTECTION TYPE DEFINITIONS.

## PLAN NOTES: NUMBERED ITEMS (NN)

IDF ROOM 118 TO BE CONSTRUCTED ON EXISTING RAISED ACCESS FLOORING

## WALLS LEGEND

EXISTING WALLS.

CONC WALLS

NEW CMU WALLS. FURRING/FACING CONDITIONS MAY VARY BY TYPE

NEW STUD WALLS. FACING CONDITIONS MAY VARY BY TYPE

#### BASE BID AND ADD ALTERNATES

ADD ALTERNATE 1A: PROVIDE WALL FRAMING AND ROUGH IN ALL PLUMBING, MECHANICAL AND ELECTRICAL FIXTURES. FLOORS, WALLS AND CEILING EXPOSED TO STRUCTURE.

ADD ALTERNATE 1B: PROVIDE FINISHED WALLS, PLUMBING, MECHANICAL AND ELECTRICAL FIXTURES. REFER TO FINISH SCHEDULE AND INTERIOR ELEVATIONS FOR ADDITIONAL INFORMATION.

ADD ALTERNATE 2: PROVIDE FINISHED WALLS, TECHNOLOGY, MECHANICAL AND ELECTRICAL FIXTURES. REFER TO FINISH SCHEDULE FOR ADDITIONAL INFORMATION.

**KEY PLAN** 

HILLSBOROUGH COUNTY SHERIFF'S (


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Date: 8/15/25


Drawn by: ER

Revisions
Revision
o. Date Description




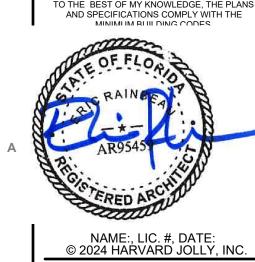


FLOOR PLAN

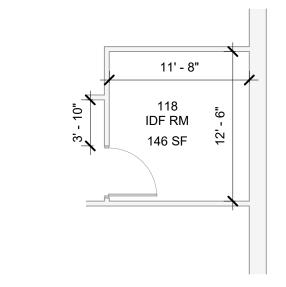

# 4 IDF ROOM 118 1/8" = 1'-0"

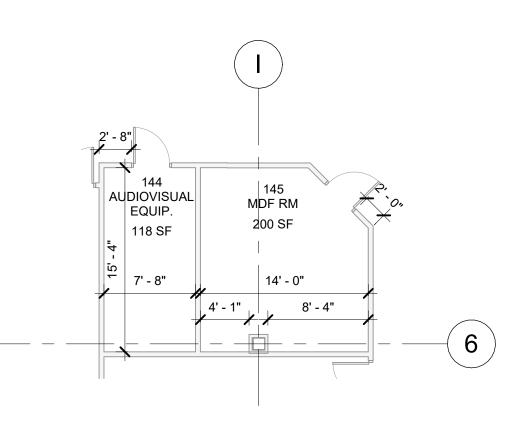

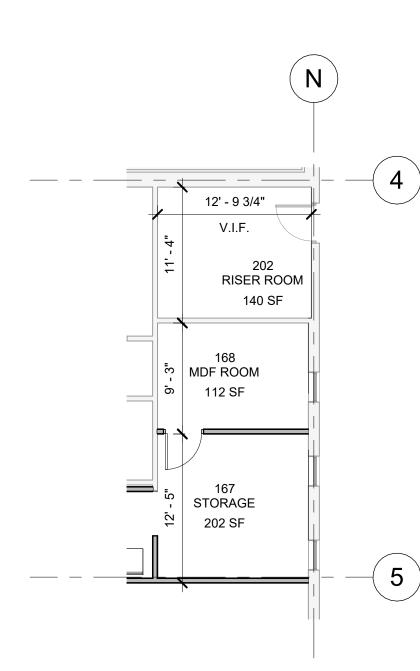

2 MDF ROOM 168

1/8" = 1'-0"

#### **DIMENSIONING CONVENTIONS:**

INTERIOR DIMENSIONS ARE FROM FACE OF FINISH TO FACE LOCATE OPENINGS IN STUD PARTITIONS 6" FROM ADJACENT PARTITIONS. U.N.O.

## ABBREVIATION CONVENTIONS:

M.O. = MASONRY OPENING R.O. = ROUGH OPENING CLEAR = CLEAR OPENING V.I.F. = VERIFY IN FIELD +/- = PLUS/MINUS C.L. = CENTER LINE

ALIGN = LINE UP TYP. = TYPICAL CONT. = CONTINUOUS MIN. = MINIMUM P.O.B. = POINT OF BEGINNING

#### **PARTITION TYPES GENERAL NOTES:**

- STC RATINGS INDICATED ARE SOURCED FROM THE LATEST EDITION OF THE GYPSUM ASSOCIATION (GA-600) SOUND
- CONTROL MANUAL. U.L DESIGN NO.'S INDICATED ARE SOURCED FROM THE LATEST EDITION OF THE UNDERWRITERS LABORATORIES INC. (FIRE RESISTANCE) DIRECTORY.
- ALL PARTITIONS ARE TYPE S4A U.N.O.
- ALL GYPSUM BOARD SHALL BE TYPE X U.N.O. STAGGER ELECTRICAL BOXES AND OTHER DEVICES IN
- ACOUSTICAL PARTITIONS 16" MINIMUM. DEVICES AND EQUIPMENT INSTALLED IN FIRE RATED PARTITIONS SHALL NOT COMPROMISE THE FIRE
- RESISTANCE INTEGRITY OF THE PARTITION. ANY PARTITION REQUIRED TO HAVE PROTECTED OPENINGS OR PENETRATIONS SHALL BE EFFECTIVELY AND PERMANENTLY IDENTIFIED WITH SIGNS OR STENCILING IN
- Ed.) 703.7. PROVIDE METAL SUPPORT IN PARTITIONS TO RECEIVE

THE CONCEALED SPACE IN ACCORDANCE WITH FBC (8 TH

WALL MOUNTED EQUIPMENT, CABINETS, HANDRAILS, ACCESSORIES, ETC.

#### 9. REFER TO A-100 FOR ADD ALTERNATE INFORMATION.

LETTER INDICATES PARTITION CORE MATERIAL NUMBER INDICATES PARTITION CORE NOMINAL THICKNESS LETTER INDICATES PARTITION MODIFIER



#### WALLS LEGEND

**PARTITION TAGS:** 


EXISTING WALLS. CONC WALLS


NEW CMU WALLS. FURRING/FACING CONDITIONS MAY VARY BY TYPE NEW STUD WALLS. FACING CONDITIONS MAY VARY BY TYPE

**KEY PLAN** 


Comm. No: 23106.01

Drawn by: ER

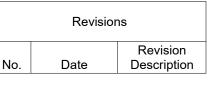

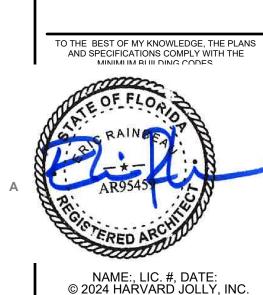

DIMENSION FLOOR PLAN

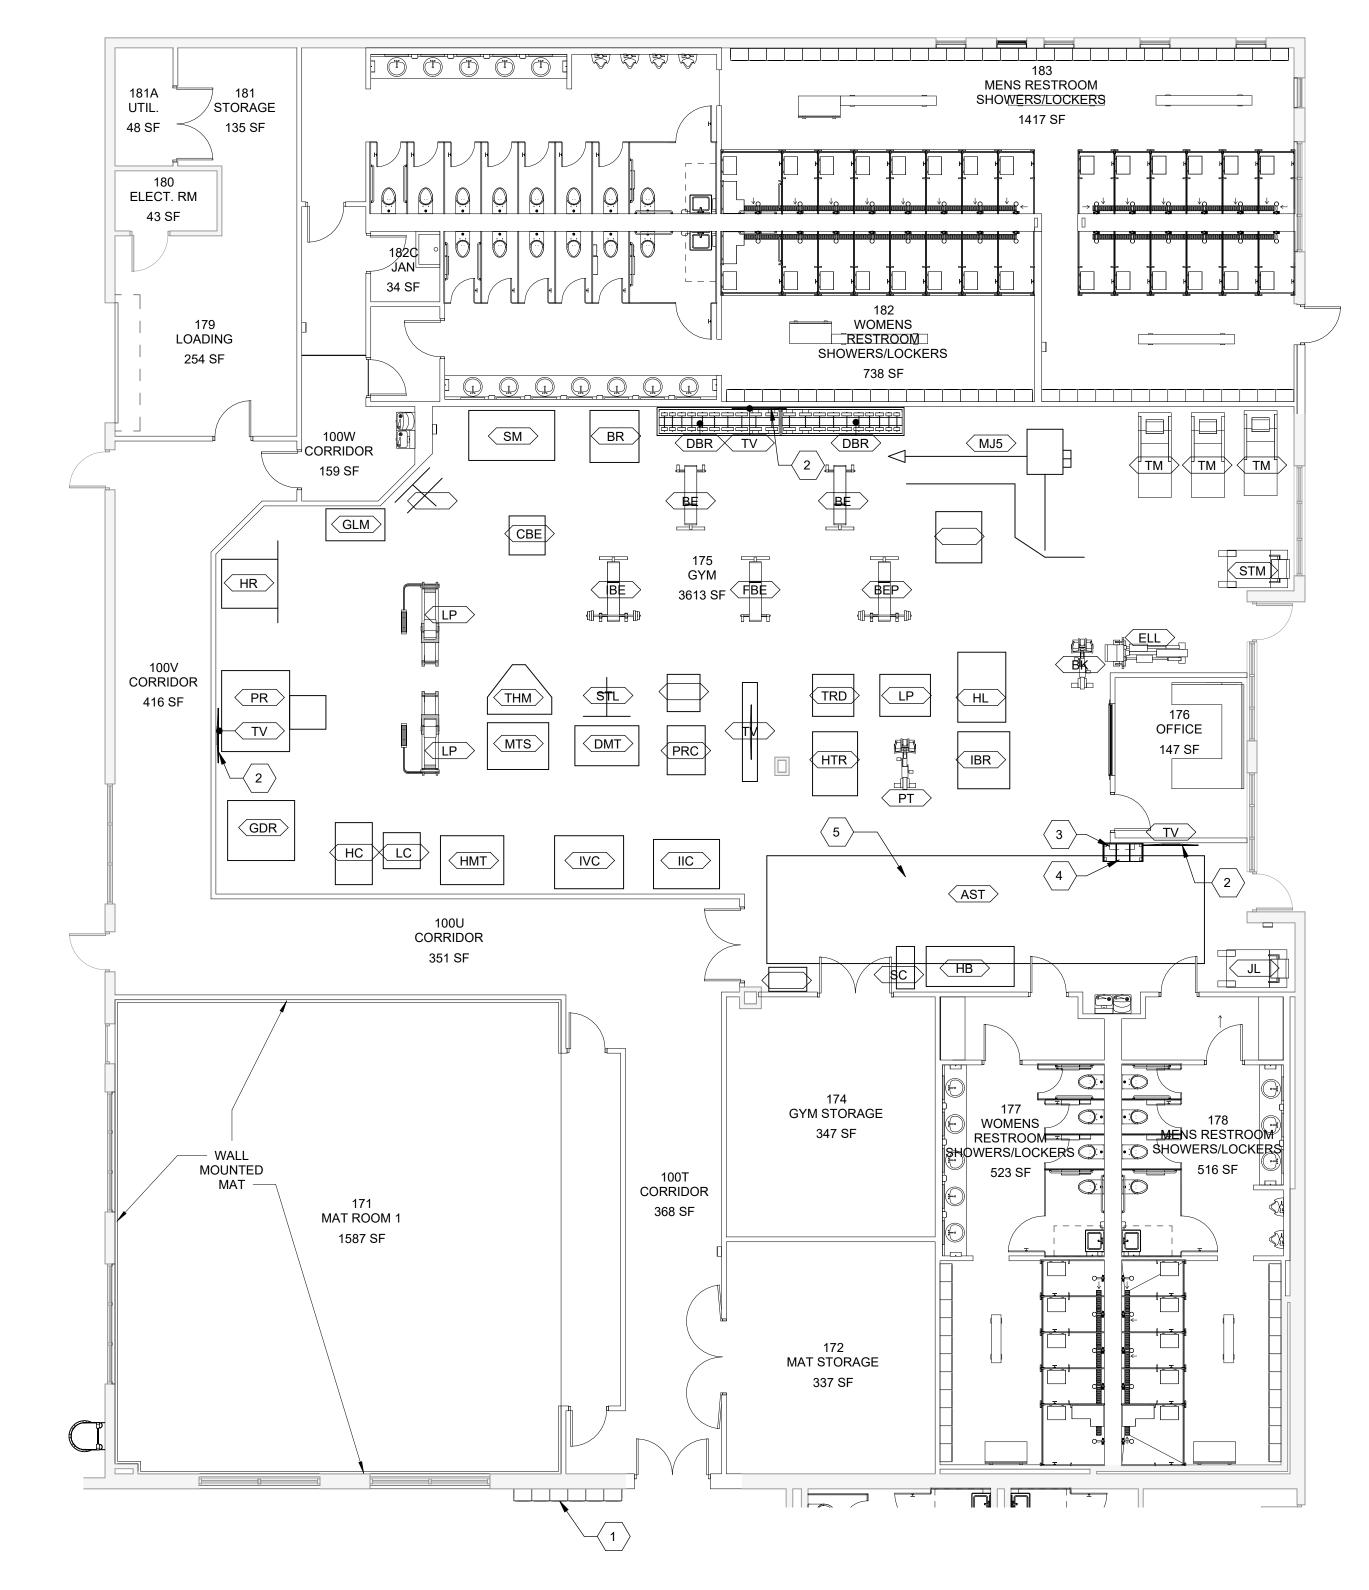

FURNITURE & EQUIPMENT PLAN - PHASE 1

#### EQUIPMENT NOTES:

GENERAL - IT IS THE INTENT OF THE CONTRACT DOCUMENTS TO PROVIDE FOR A COMPLETE AND FUNCTIONAL EQUIPMENT INSTALLATION. OWNER FURNISHED EQUIPMENT SHALL BE VERIFIED PRIOR TO ROUGH-IN TO DETERMINE ALL REQUIREMENTS, INCLUDING, BUT NOT LIMITED TO SIZES, CLEARANCES, BLOCKING, METAL BACK-UP, ELECTRICAL, MECHANICAL, PLUMBING, SUPPORT, ETC. THE GENERAL CONTRACTOR SHALL ASSURE THAT ALL NECESSARY REQUIREMENTS HAVE BEEN INCLUDED IN A TIMELY MANNER SO AS NOT TO DELAY THE WORK AND TO PROVIDE FOR COMPLETE EQUIPMENT INSTALLATIONS. OWNER FURNISHED ITEMS - COORDINATE ALL EQUIPMENT INSTALLATION WITH THE OWNER. TAKE CARE TO PREVENT ANY DAMAGE TO OWNER FURNISHED EQUIPMENT. PHASING - COORDINATE EQUIPMENT DELIVERIES AND INSTALLATION WITH THE PHASING PLAN FOR APPROPRIATE SCHEDULING. REFER ALSO TO OWNER'S EQUIPMENT SCHEDULE, PROVIDED BY EQUIPMENT CONSULTANT, FOR ADDITIONAL INFORMATION. SEE NUMBERED NOTES FOR FURNISHINGS U.O.N. ON

INTERIORS DRAWINGS.

| EQUIPMENT LEGEND |                    |      |  |  |  |  |
|------------------|--------------------|------|--|--|--|--|
| ITEM             | DESCRIPTION        | BY   |  |  |  |  |
| (AST)            | ASTRO TURF         | OFOI |  |  |  |  |
| BE               | BENCH              | OFOI |  |  |  |  |
| BEP              | BENCH PRESS        | OFOI |  |  |  |  |
| ВК               | BIKE               | OFOI |  |  |  |  |
| CBE              | CURL BENCH         | OFOI |  |  |  |  |
| DBR              | DUMBBELL RACKS     | OFOI |  |  |  |  |
| (DMT)            | DEADLIFT MTS       | OFOI |  |  |  |  |
| ELL              | ELLIPTICAL         | OFOI |  |  |  |  |
| (FBE)            | FLAT BENCH         | OFOI |  |  |  |  |
| (GDR)            | GLUTE DRIVE        | OFOI |  |  |  |  |
| (GLM)            | GLUTE MACHINE      | OFOI |  |  |  |  |
| (HB)             | HEAVY BAG          | OFOI |  |  |  |  |
| HC               | HAMSTRING CURL     | OFOI |  |  |  |  |
| HL               | HOIST LAT          | OFOI |  |  |  |  |
| (HMT)            | HAMSTRING MACHINE  | OFOI |  |  |  |  |
| HR               | HALF RACK          | OFOI |  |  |  |  |
| (HTR)            | HOIST TRI          | OFOI |  |  |  |  |
| (IBE)            | INCLINED BENCH     | OFOI |  |  |  |  |
| (IBR)            | ISO BACK ROW       | OFOI |  |  |  |  |
| (IIC)            | SO INCLINED CHEST  | OFOI |  |  |  |  |
| (IVC)            | OSP VERTICAL CHEST | OFOI |  |  |  |  |
| JL               | JACOBS LADDER      | OFOI |  |  |  |  |
| LC               | LEG CURL           | OFOI |  |  |  |  |
| LP               | LEG PRESS          | OFOI |  |  |  |  |
| (LPD)            | LAT PULLDOWN       | OFOI |  |  |  |  |
| MJ5              | MJ5                | OFOI |  |  |  |  |
| (MTS)            | MTS SHL            | OFOI |  |  |  |  |
| PR               | POWER RACK         | OFOI |  |  |  |  |
| PRC              | PR CURL            | OFOI |  |  |  |  |
| PT               | PELETON            | OFOI |  |  |  |  |
| SC               | SCALE              | OFOI |  |  |  |  |
| SGS              | UNKNOWN            | OFOI |  |  |  |  |
| SM               | SMITH MACHINE      | OFOI |  |  |  |  |
| STL              | STANDING LATERAL   | OFOI |  |  |  |  |
| (STM)            | STAIR MASTER       | OFOI |  |  |  |  |
| (THM)            | THIGH MACHINE      | OFOI |  |  |  |  |
| TM               | TREADMILL          | OFOI |  |  |  |  |
| TV               | TELEVISION         | OFOI |  |  |  |  |
|                  |                    |      |  |  |  |  |

OFOI: OWNER FURNISH, OWNER INSTALL
OFCI: OWNER FURNISH, CONTRACTOR INSTALL
CFCI: CONTRACTOR FURNISH, CONTRACTOR
INSTALL

## DRAWING KEYNOTES: NN

TRD TRI DIP

LOCKERS
TV ON UNIVERSAL MOUNT. 7'-0" AFF TO CENTERLINE OF MOUNT.
WALL MOUNTED GUN LOCKERS
3X4 STORAGE CUBIES
ASTRO TURF TO BE INSTALLED LEVEL WITH RUBBER GYM

**KEY PLAN** 


OFOI


| HILLSBOR     | TRAINING A  | PERMIT DOCL |
|--------------|-------------|-------------|
| Comm.        | No: 23106.0 | 01          |
| Date:        | 8/15/25     | 5           |
| Drawn        | by: ER      |             |
| DESIGN PHASE | <br>E:      |             |

S ACADEMY HORST ROAD, 1

COUNTY

SBOROUGH

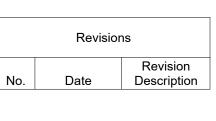


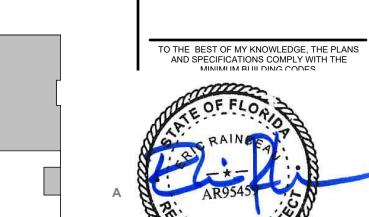


NAME:, LIC. #, DATE:
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FURNITURE &
EQUIPMENT PLAN

4 RCP IDF ROOM 118

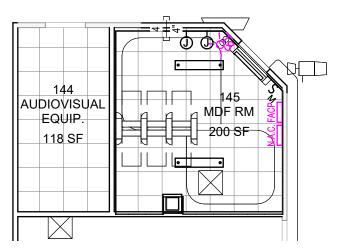

3 RCP MDF ROOM 145

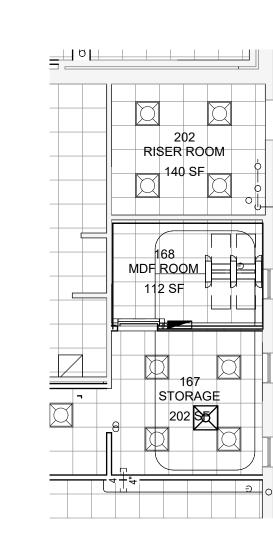

2 RCP MDF ROOM 168



REFLECTED CEILING PLAN - PHASE 1

REFLECTED CEILING LEGEND

LAY-IN CEILING SYSTEM ACT-1

LAY-IN CEILING SYSTEM ACT-2

GYPSUM WALL BOARD CEILING SYSTEM GWB

OPEN TO STRUCTURE

(SIZE, TYPE, AND GRAPHICS ON PLANS MAY 2X4 RECESSED LUMINAIRE

2X2 RECESSED LUMINAIRE 1X4 RECESSED LUMINAIRE

SHOP LIGHT WITH HOOD SURFACE MOUNTED STRIP LUMINAIRE TAPE/ TRACK / LINEAR/ SUSPENDED BOX

RECESS CAN DOWNLIGHT. SIZE VARIES PENDANT LIGHT. SIZE AND TYPE VARIES

WALL LIGHT FIXTURE. SIZE AND TYPE VARIES MINI PENDANT LIGHT. SIZE AND TYPE VARIES

ILLUMINATED EXIT SIGN, SINGLE FACE, W/ DIRECTION ARROW (REFER TO ELECTRICAL DRAWINGS). F/A SMOKE DETECTOR (REFER TO ELECTRICAL DRAWINGS). F/A HEAT DETECTOR (REFER TO

ELECTRICAL DRAWINGS). SPRINKLER HEAD (REFER TO FP DRAWINGS). CONCEALED SPRINKLER HEAD (REFER TO FP DRAWINGS).

DIFFUSER GRILLE (REFER TO MECH. DRAWINGS). RETURN AIR GRILLE (REFER TO MECH. DRAWINGS).

∠ AP-[--] (SIZE PER NOTES AND OR MECHANICAL DRAWINGS)

EXHAUST GRILLE (REFER TO MECH. DRAWINGS).

CEILING MOUNTED SPEAKER (REFER TO ELECTRICAL DRAWINGS). EMERGENCY CALL DOME LIGHT (REFER TO ELECTRICAL DRAWINGS).

INDICATES CEILING HEIGHT AFF IN FEET AND INCHES & INDICATES CEILING TYPE

EXPOSED STRUCTURE (NO CEILING) GWB ON THIS ROOM SIDE OF DEMISING PARTITIONS SHALL EXTEND TO UNDERSIDE OF DECK ABOVE. ADDITIONAL REQUIREMENTS MAY BE NECESSARY IF PARTITION INDICATES A FIRE, SMOKE OR SOUND TRANSMISSION RATING

#### WALLS LEGEND

EXISTING WALLS. CONC WALLS

NEW CMU WALLS. FURRING/FACING CONDITIONS MAY VARY BY TYPE

NEW STUD WALLS. FACING CONDITIONS MAY VARY BY TYPE

REFER ALSO TO MECHANICAL ELECTRICAL DRAWINGS FOR ADDITIONAL CRITERIA ON ABOVE SYSTEMS AS CENTER SYSTEMS IN CEILINGS ADJACENT TO DOORS ON CENTER OF DOORS OR CENTER OF NEAREST LAY-IN IT IS THE INTENT OF THE CEILING DESIGN TO HAVE VISIBLE DEVICES ALIGNED IN FINISHED AREAS TO THE GREATEST EXTENT POSSIBLE U.O.N. AND TO BE

CENTERED ON CENTER OF LAY-IN CEILING SYSTEMS CEILING HEIGHTS - SHALL BE 10'-0" AFF U.O.N. WHERE ABUTTING EXISTING CEILINGS, HEIGHT SHALL MATCH EXISTING AT ADJACENT LOCATIONS, U.O.N. GRILLES, DIFFUSERS, REGISTERS - COORDINATE REFLECTED CEILING PLANS AND MECHANICAL PLANS. CONFLICTS SHALL BE RESOLVED PRIOR TO

INSTALLATION. FOR FIXTURES - COORDINATE REFLECTED CEILING PLAN AND ELECTRICAL LIGHTING PLAN. CONFLICTS SHALL BE RESOLVED PRIOR TO INSTALLATION. SUPPORT - DO NOT HANG SYSTEMS FROM EXISTING OR NEW METAL DECKING. CONNECT OR SUSPEND ONLY FROM STRUCTURAL MEMBERS OR MEMBERS THAT ARE SECURED TO THE STRUCTURE. ACOUSTICAL TILE SUPPORT - WHENEVER ITEMS SUCH AS SMOKE DETECTORS, SIGNAGE, SPEAKERS, ETC. ARE ATTACHED TO CEILING TILES, PROVIDE CROSS BRACE SUPPORT SECURED TO EACH SIDE OF ITEM. BRACE SHALL BE LOCATED TO PROVIDE FULL SUPPORT OF ITEM INDEPENDENTLY OF TILE WITHOUT ANY SAG, BOW OR TWIST OF CEILING OR GRID. 10. THE EXTENT OF THE CEILING WORK IS INTENDED TO BE ALL INCLUSIVE. REFER ALSO TO MECHANICAL AND

ELECTRICAL DRAWINGS.

TRAINING 10210 WINDH Comm. No: 23106.01 Date: 8/15/25 Drawn by: ER


Date

ACADEMY HORST ROAD,

SBOROUGH

TO THE BEST OF MY KNOWLEDGE, THE PLANS AND SPECIFICATIONS COMPLY WITH THE

**KEY PLAN** REFLECTED CEILING PLAN

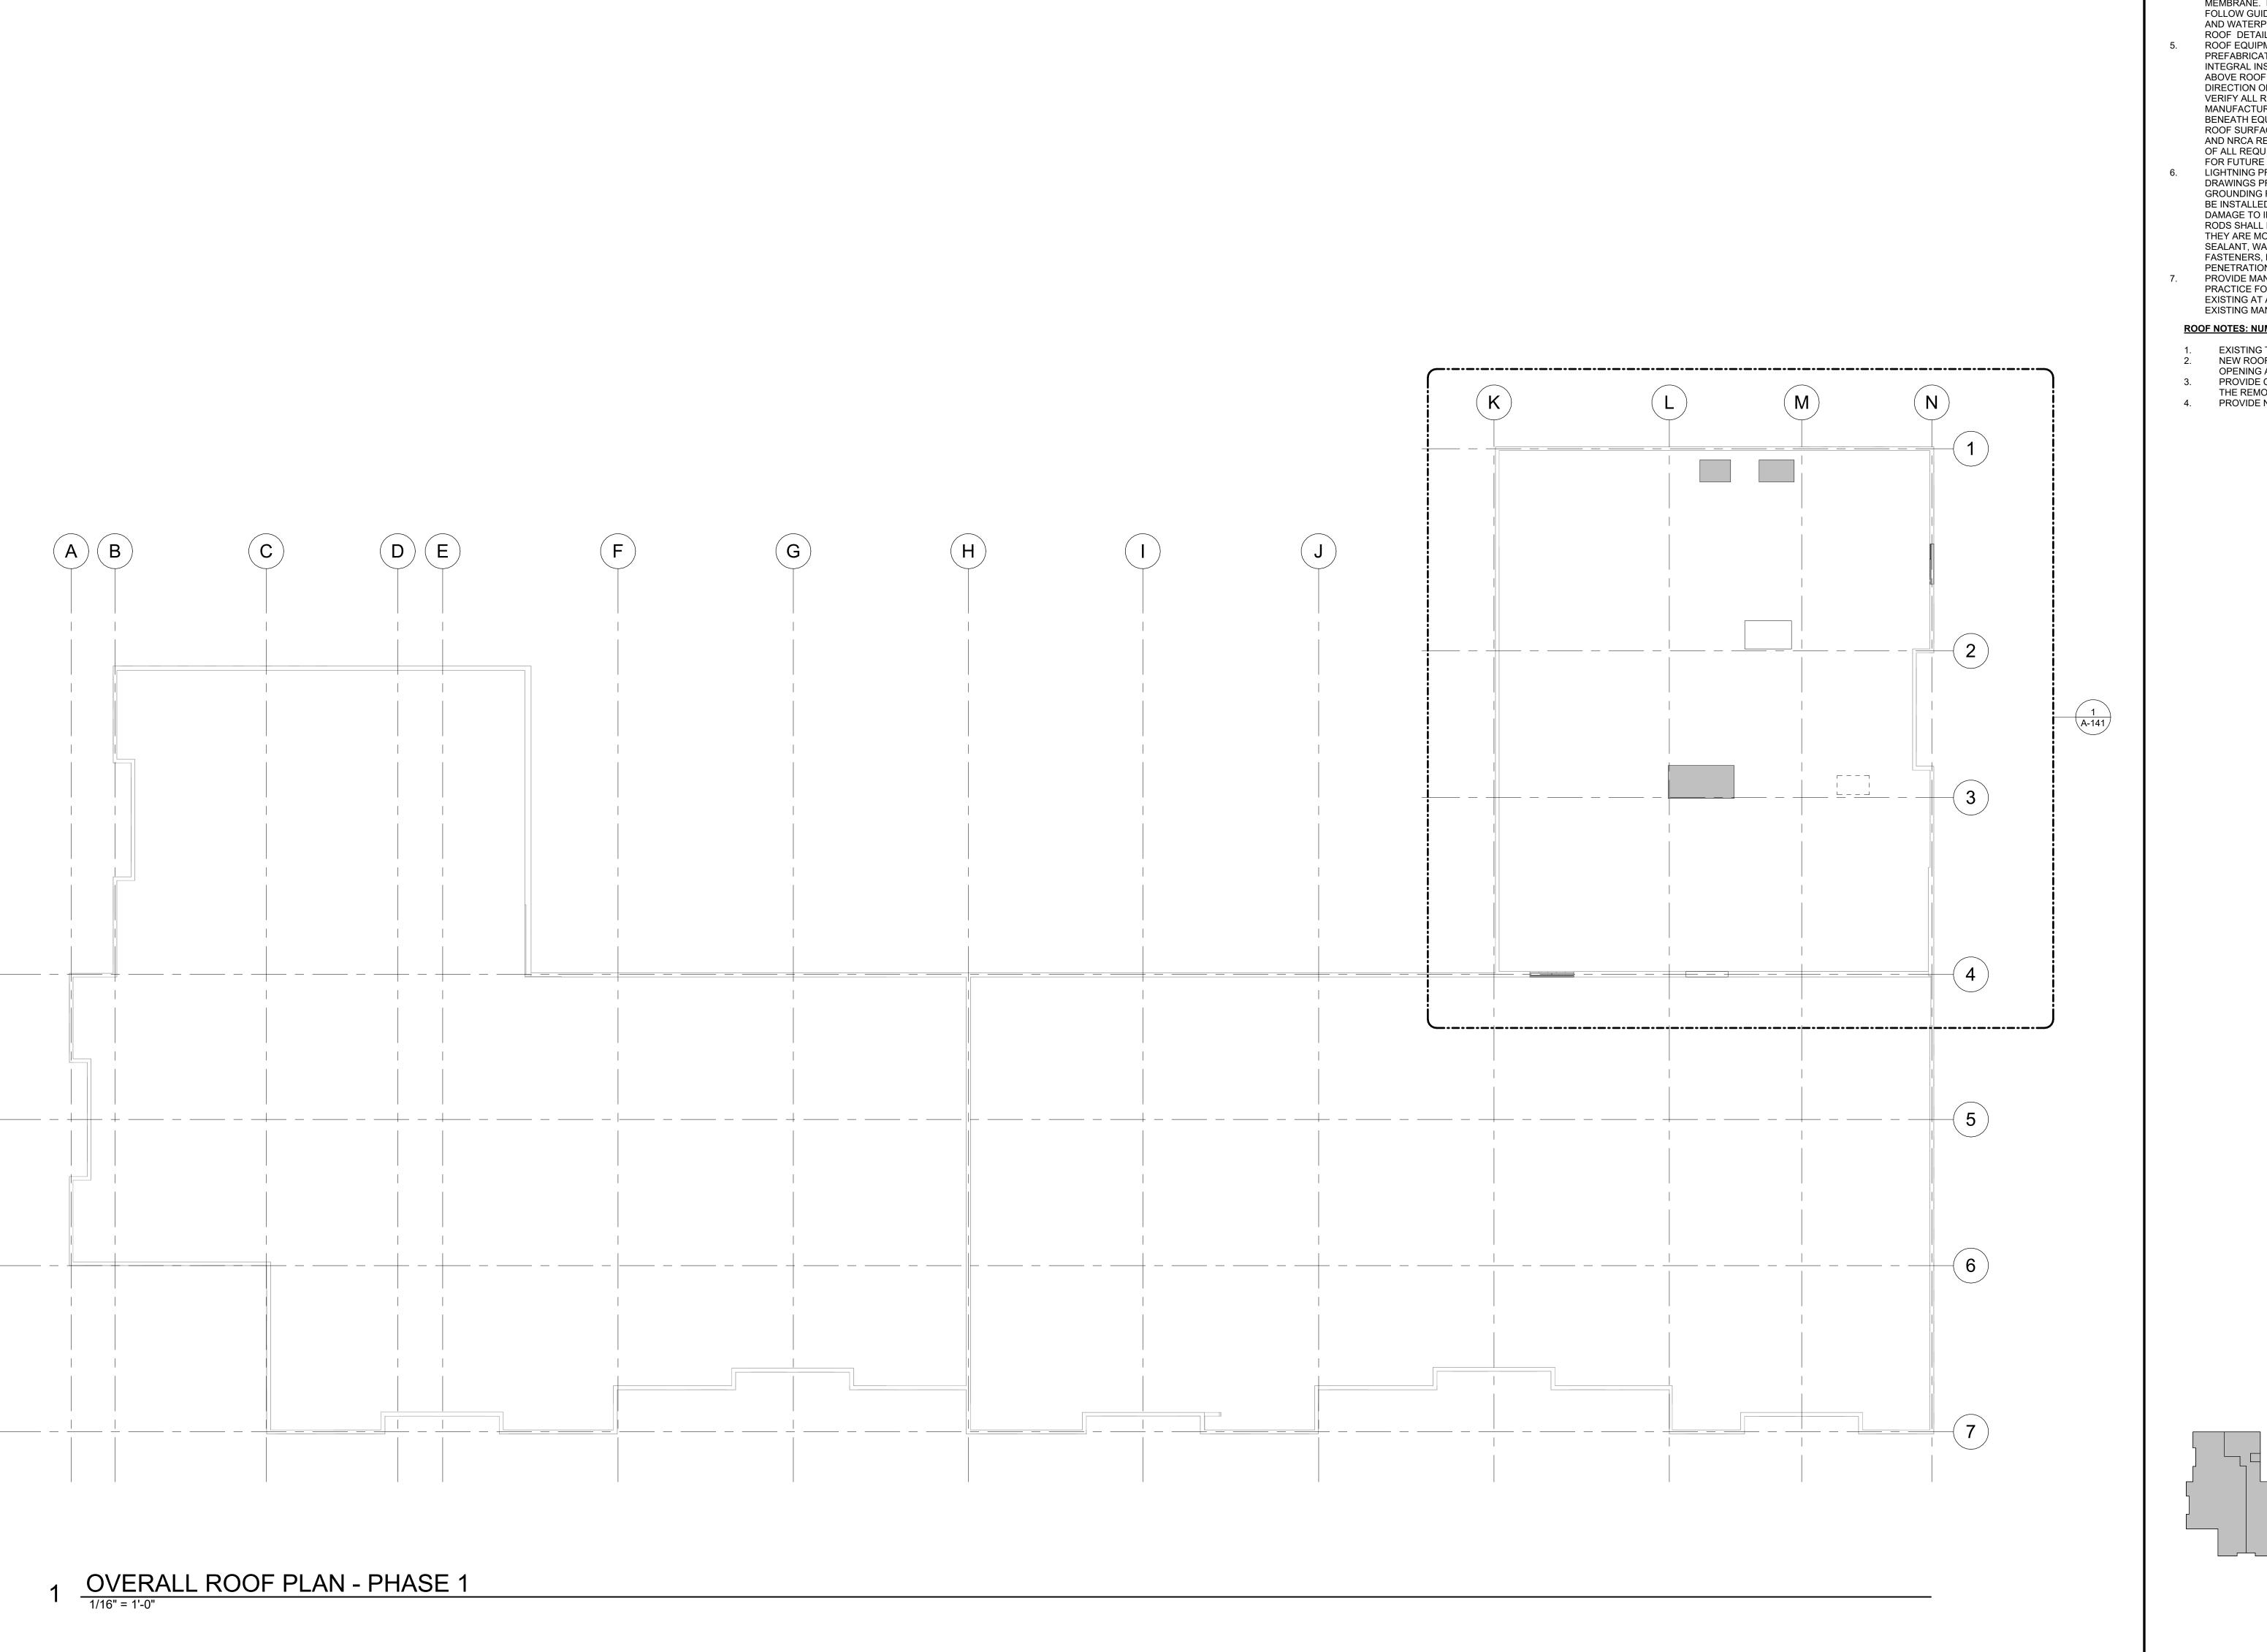

### **ROOF PLAN NOTES:**

- GENERAL IT IS THE INTENT OF THE CONTRACT DOCUMENTS TO PROVIDE FOR A COMPLETE AND WEATHERTIGHT INSTALLATION OF ALL ROOF ITEMS. PENETRATIONS, ETC. THE CONTRACTOR SHALL PROVIDE ALL ROOF ACCESSORIES, FLASHING, SEALANT, SCUPPERS, DRAINS, LABOR, MATERIALS, EQUIPMENT, ETC. REQUIRED FOR COMPLETION OF A WEATHERTIGHT ROOF INSTALLATION. FOLLOW ALL RECOMMENDATIONS OF THE NRCA REGARDING INSTALLATION PROCEDURES, UNLESS MORE STRINGENT REQUIREMENTS ARE INDICATED. ELEVATIONS - LOCATIONS THAT ARE NOTED THUS (+5") INDICATE THICKNESS OF ROOF INSULATION BOARD ABOVE
- THE TOP OF STRUCTURAL ROOF DECK OR CONCRETE SLAB, NOT INCLUDING THE PROTECTION BOARD THICKNESS, IF ANY. SLOPE - ROOF SURFACE SHALL HAVE A MINIMUM SLOPE OF 1/4" PER FOOT IN A PERPENDICULAR DIRECTION FROM THE
  - ROOF EDGE DOWN TOWARD THE ROOF DRAINS AS INDICATED BY THE ARROWS DRAWN ON THE ROOF PLAN. WHERE REQUIRED TO FACILITATE DRAINAGE, PROVIDE VALLEYS, CRICKETS, RIDGES, ETC. OF REQUIRED SLOPE TO PROPERLY DRAIN ALL ROOF SURFACES. PENETRATIONS - PROPERLY FLASH, WATERPROOF,
- SECURE AND SEAL ALL ITEMS THAT PENETRATE THE ROOF MEMBRANE. DO NOT INSTALL ANY PITCH POCKETS. FOLLOW GUIDELINES OF NRCA CONCERNING FLASHING AND WATERPROOFING ALL ROOF PENETRATIONS. SEE ROOF DETAILS.
- ROOF EQUIPMENT MOUNT ALL ROOF EQUIPMENT ON PREFABRICATED EQUIPMENT SUPPORT CURBS WITH INTEGRAL INSULATION. WHERE EQUIPMENT IS RAISED ABOVE ROOF SURFACE, ALIGN SUPPORTS PARALLEL TO DIRECTION OF WATERFLOW TO FACILITATE DRAINAGE. VERIFY ALL REQUIREMENTS WITH EQUIPMENT AND CURB MANUFACTURERS. WHERE ROOF MEMBRANE EXTENDS BENEATH EQUIPMENT, MOUNT EQUIPMENT ABOVE THE ROOF SURFACE IN ACCORDANCE WITH BUILDING CODE AND NRCA REQUIREMENTS TO ALLOW FOR INSTALLATION OF ALL REQUIRED ROOFING COMPONENTS AND TO ALLOW FOR FUTURE OWNER MAINTENANCE.
- LIGHTNING PROTECTION REFER TO ELECTRICAL DRAWINGS PROTECTION FOR ALL LIGHTNING PROTECTION. GROUNDING RODS, CABLES, CONNECTIONS, ETC. SHALL BE INSTALLED IN SUCH A MANNER TO PREVENT ANY DAMAGE TO INSTALLED ROOF MEMBRANE. GROUNDING RODS SHALL BE FASTENED TO THE SUBSTRATE ON WHICH THEY ARE MOUNTED. PROVIDE ALL REQUIRED FLASHING, SEALANT, WATERPROOFING, NON-CORROSIVE FASTENERS, ETC. AT EACH LOCATION AND AT MEMBRANE PENETRATION POINTS.
- PROVIDE MANUFACTURERS STANDARD RECOMMENDED PRACTICE FOR APPLICATION OF NEW ROOFING TO EXISTING AT AREAS OF INFILL. CONTRACTOR TO MATCH EXISTING MANUFACTURER, PRODUCT AND THICKNESS.

## ROOF NOTES: NUMBERED ITEMS (NN)

- EXISTING TO REMAIN.
- NEW ROOFTOP EQUIPMENT, MODIFY EXISTING ROOF OPENING AS REQUIRED FOR NEW EQUIPMENT. PROVIDE CAP TO SEAL CURBED OPENING CREATED BY


**KEY PLAN** 

THE REMOVAL OF EQUIPMENT. 4. PROVIDE NEW PIPE FLASHING AT CHILLER UNIT.

Comm. No: 23106.01




OVERALL ROOF PLAN

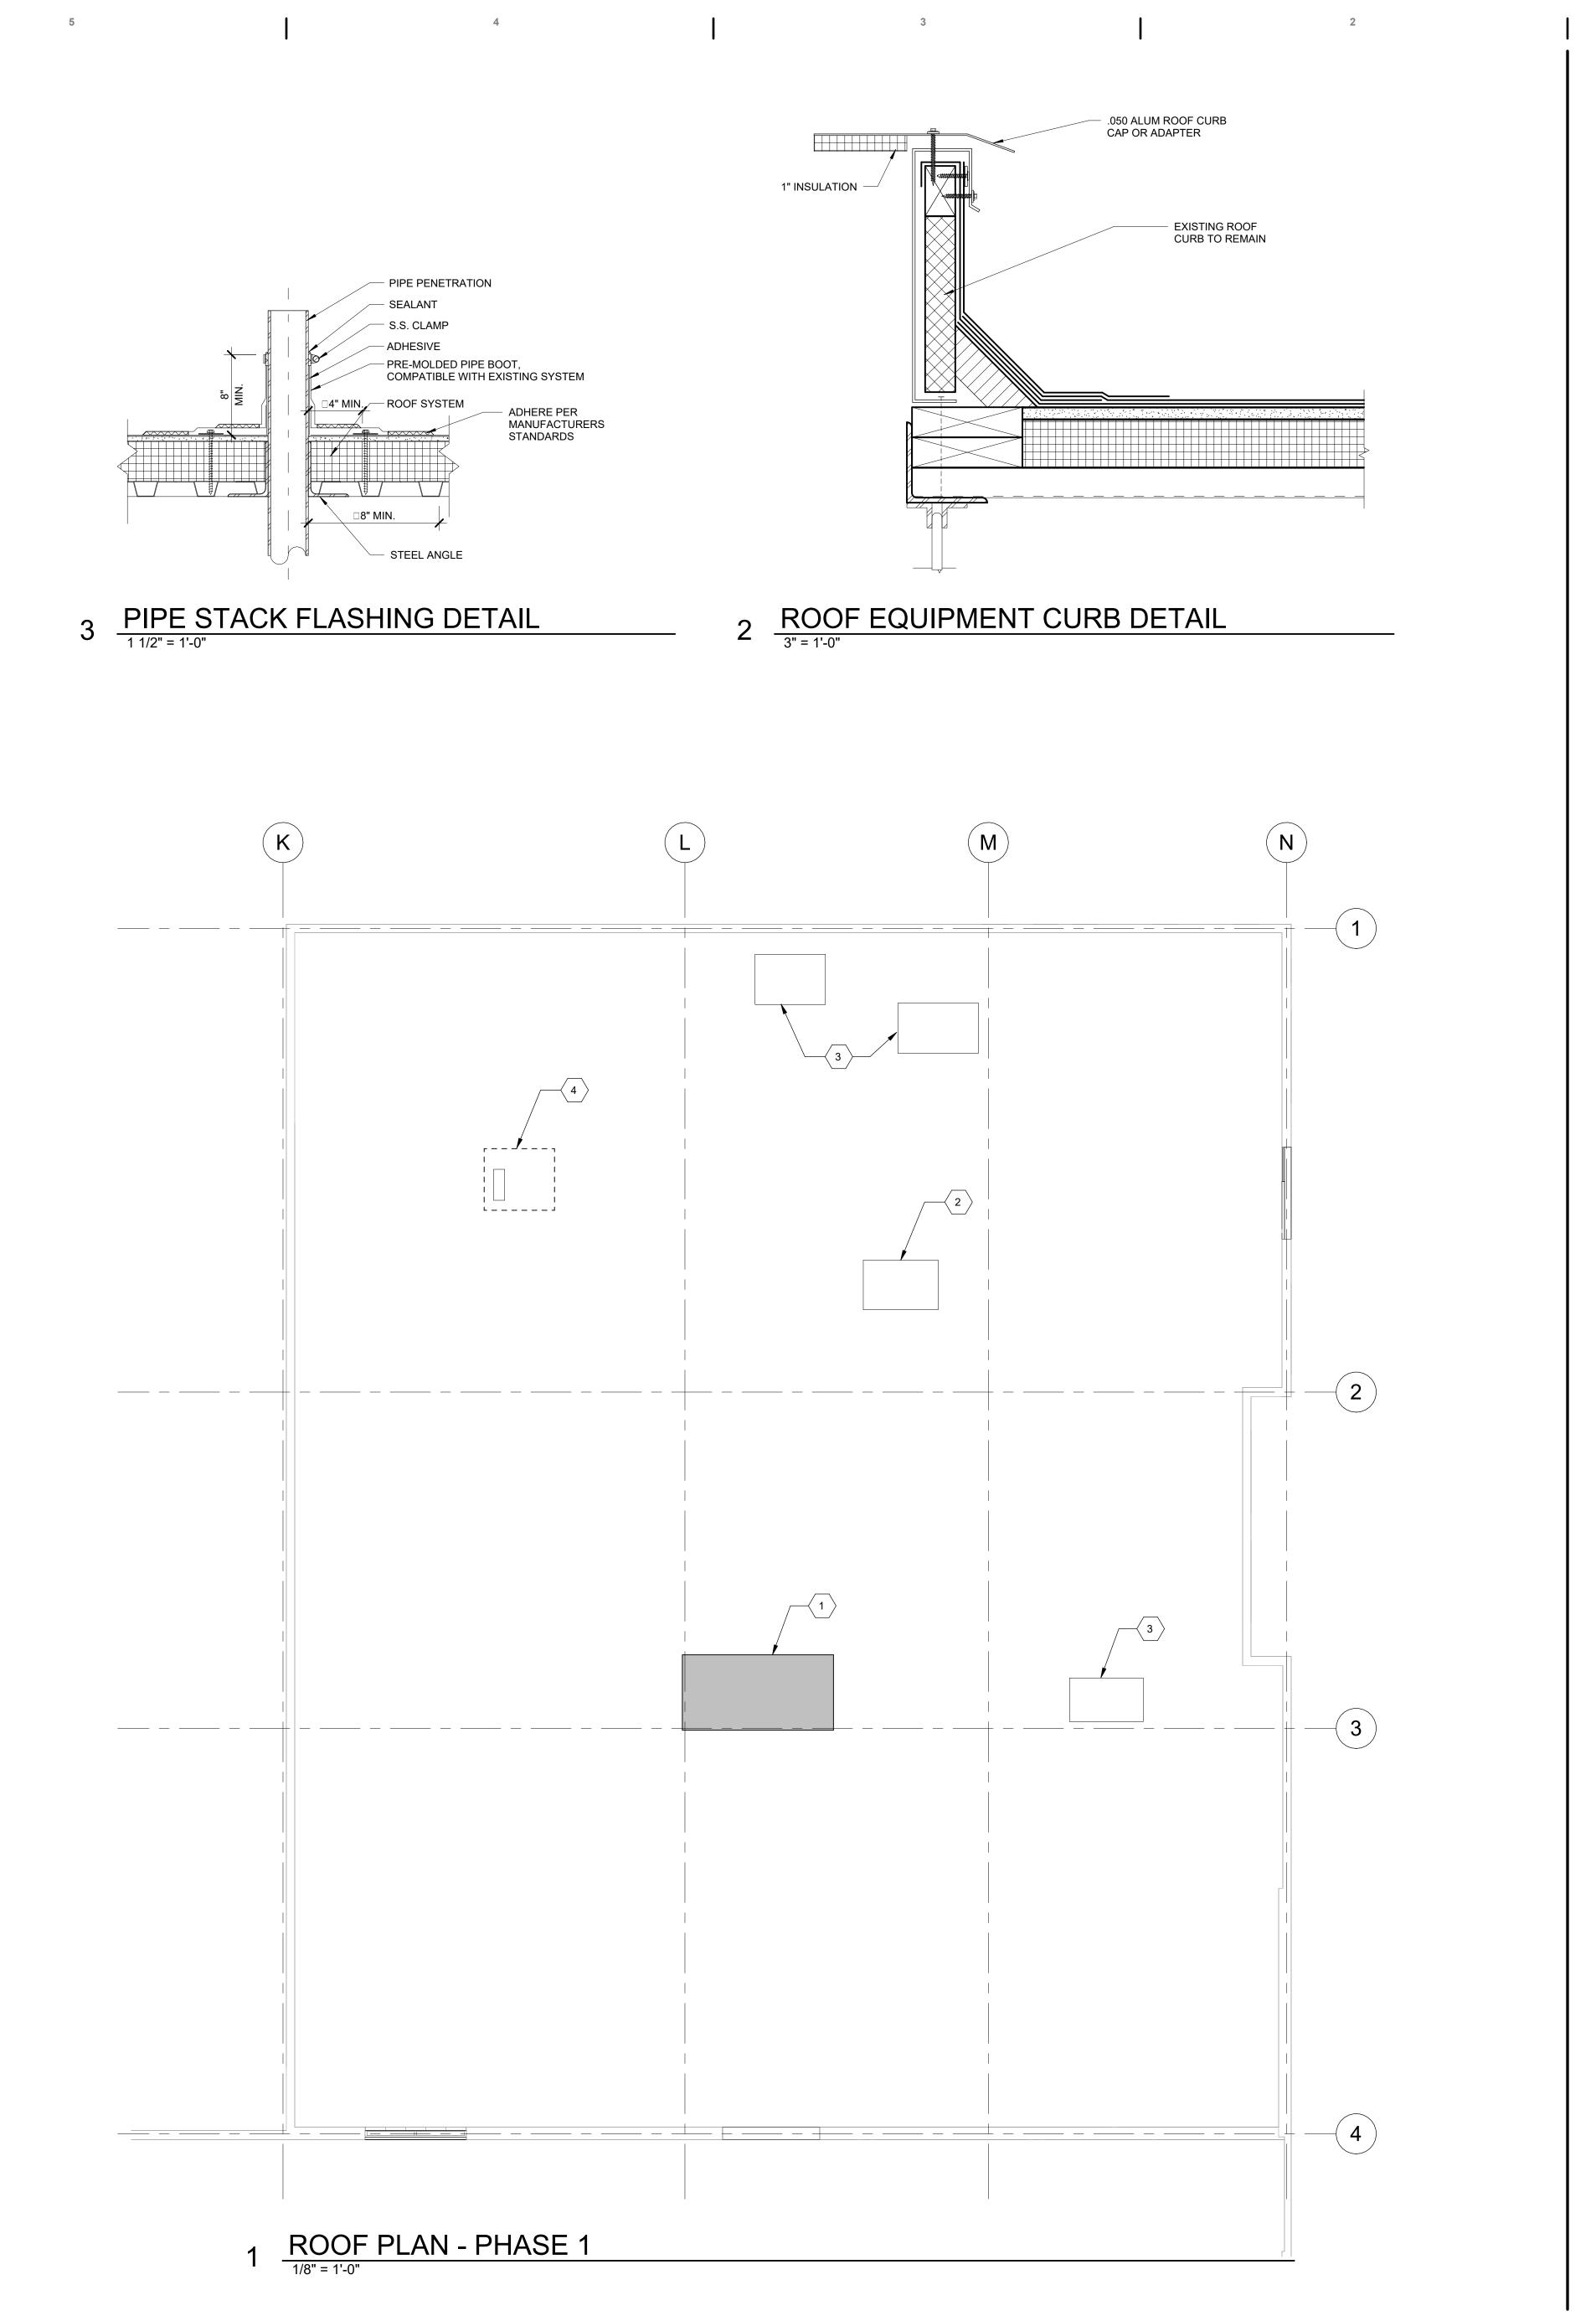


ROOF NOTES: NUMBERED ITEMS (NN)


- EXISTING TO REMAIN.
   NEW ROOFTOP EQUIPMENT, MODIFY EXISTING ROOF OPENING AS REQUIRED FOR NEW EQUIPMENT.
   PROVIDE CAP TO SEAL CURBED OPENING CREATED BY THE REMOVAL OF EQUIPMENT.
   PROVIDE NEW PIPE FLASHING AT CHILLER UNIT.

Comm. No: 23106.01 Drawn by: ER

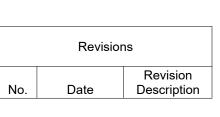

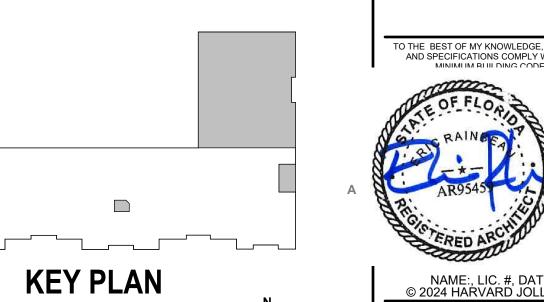


NAME:, LIC. #, DATE: © 2024 HARVARD JOLLY, INC. **ROOF PLAN** 

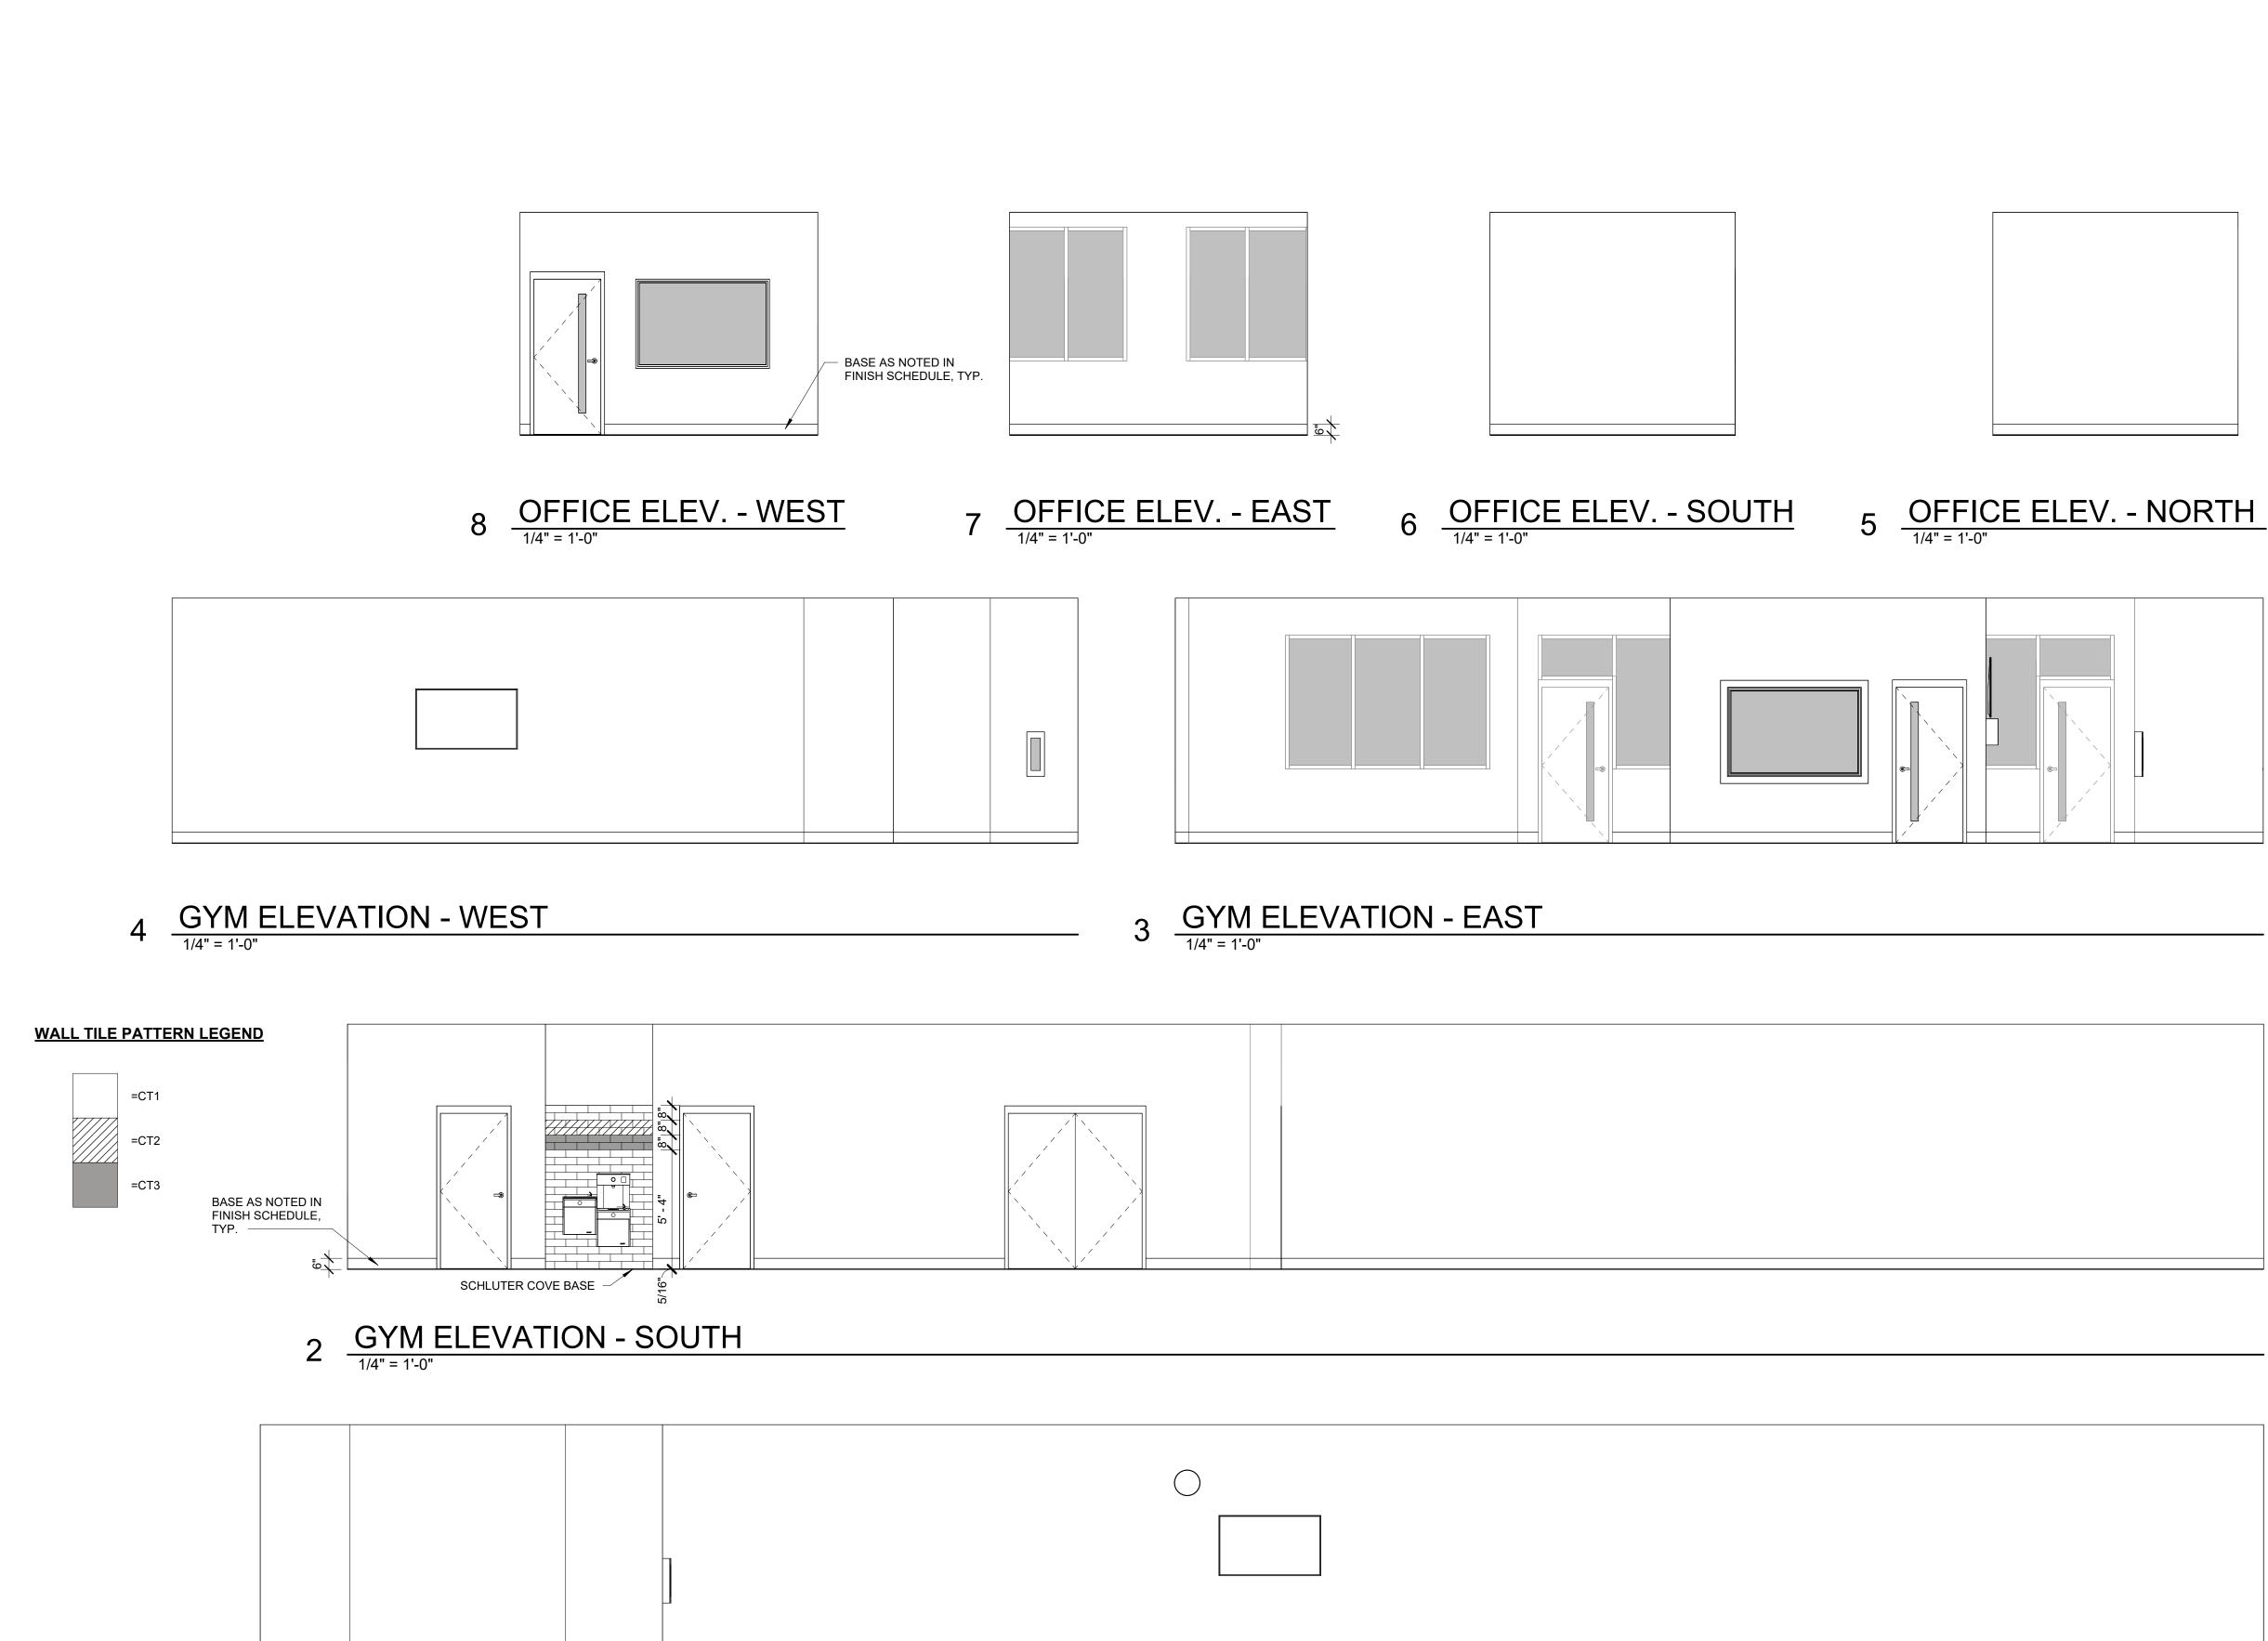

GYM ELEVATION - NORTH

1/4" = 1'-0"

2 DIMENSION PLAN CADET RESTROOM - PHASE 1

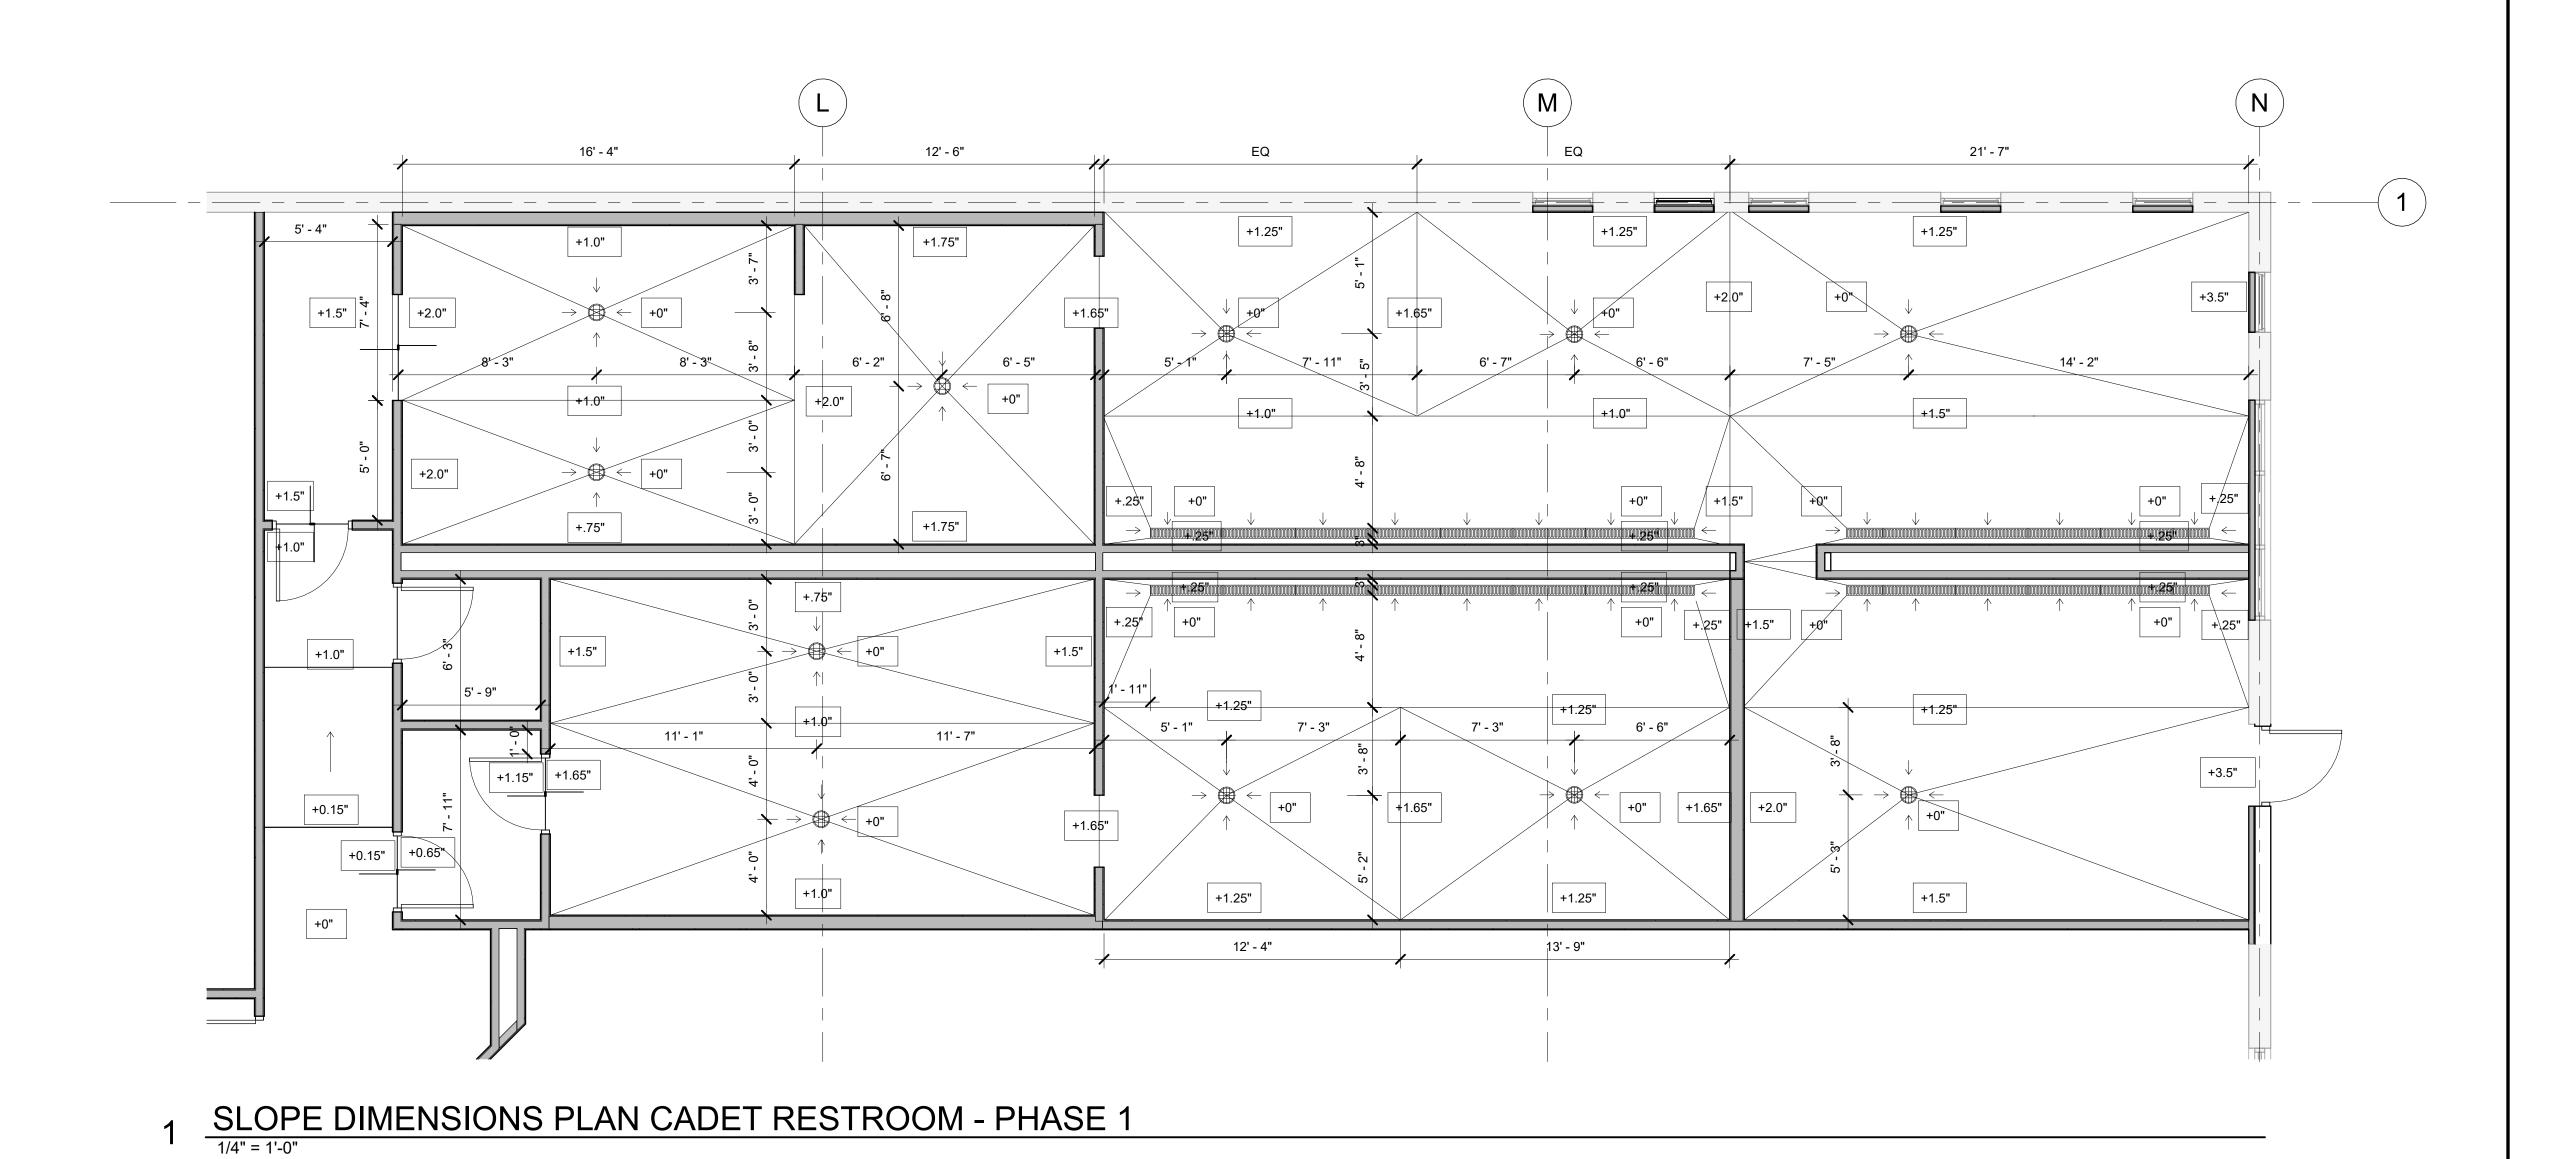

**GENERAL NOTES:** 

1. REFER TO A-401 FOR TYPICAL AND ADDITIONAL RESTROOM AND SHOWER STALL INFORMATION. 2. REFER TO A-410 FOR ADDITIONAL ADA INFORMATION.


ADA CLEAR SPACE


**DRAWING KEYNOTES:** (NN) ADA BENCH

BENCH

Comm. No: 23106.01

Drawn by: ER

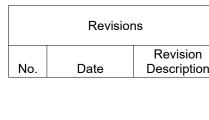

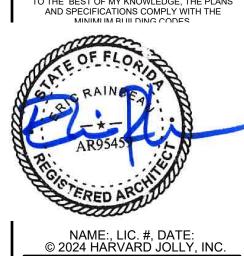

A-400

**ENLARGED PLANS** 

| ITEM | SSORIES LEGEND           |                 |    |
|------|--------------------------|-----------------|----|
| XX-N | DESCRIPTION              | MOUNTING HEIGHT | E  |
| GB-1 | GRAB BAR                 | SEE A-410       | CI |
| GB-2 | GRAB BAR                 | SEE A-410       | CF |
| GB-3 | GRAB BAR                 | SEE A-410       | CF |
| GB-4 | GRAB BAR                 | SEE A-410       | CF |
| MR-1 | MIRROR                   | SEE A-410       | CF |
| PTD  | PAPER TOWEL DISPENSER    | SEE A-410       | OF |
| SD   | SOAP DISPENSER           | SEE A-410       | OI |
| SND  | SANITARY NAPKIN DISPOSAL | SEE A-410       | CF |
| TPH  | TOILET PAPER DISPENSER   | SEE A-410       | OF |
| SS-1 | SHOWER SEAT              | SEE A-410       | CF |
| SS-2 | SHOWER SEAT              | SEE A-410       | CF |
| SH   | SHOWER HEAD              | SEE A-410       | CF |
| RH-1 | ROBE HOOK                | SEE A-410       | CF |
| RH-2 | ROBE HOOK                | SEE A-410       | CF |
| CR   | CURTAIN ROD              | SEE A-410       | CF |
| SC-1 | SHOWER CURTAIN           | SEE A-410       | CF |
| SC-2 | SHOWER CURTAIN           | SEE A-410       | CF |

NOTES:

1. CONTRACTOR TO FURNISH AND INSTALL CONCEALED WOOD BLOCKING (WITHIN WALLS) AS REQUIRED TO FIRMLY SECURE WALL-MOUNTED EQUIPMENT AND/OR ACCESSORIES. ALL WOOD BLOCKING IN CONTACT WITH MASONRY IS TO BE PRESSURE TREATED.

CFCI: CONTRACTOR FURNISH AND INSTALL OFCI: OWNER FURNISH AND CONTRACTOR INSTALL OFOI: OWNER FURNISH AND OWNER INSTALL

FLOOR MOUNTED HOPE PANEL SYSTEM

SSTEM

SS-0

T-2'

SS-1

SS


3 TYPICAL AMBULATORY TOILET STALL

1/2" = 1'-0"


2 TYPICAL TOILET AND SHOWER STALL

1/2" = 1'-0"

NOTE: SANITARY NAPKIN DISPENSER IN WOMEN'S RESTROOM STALLS ONLY.

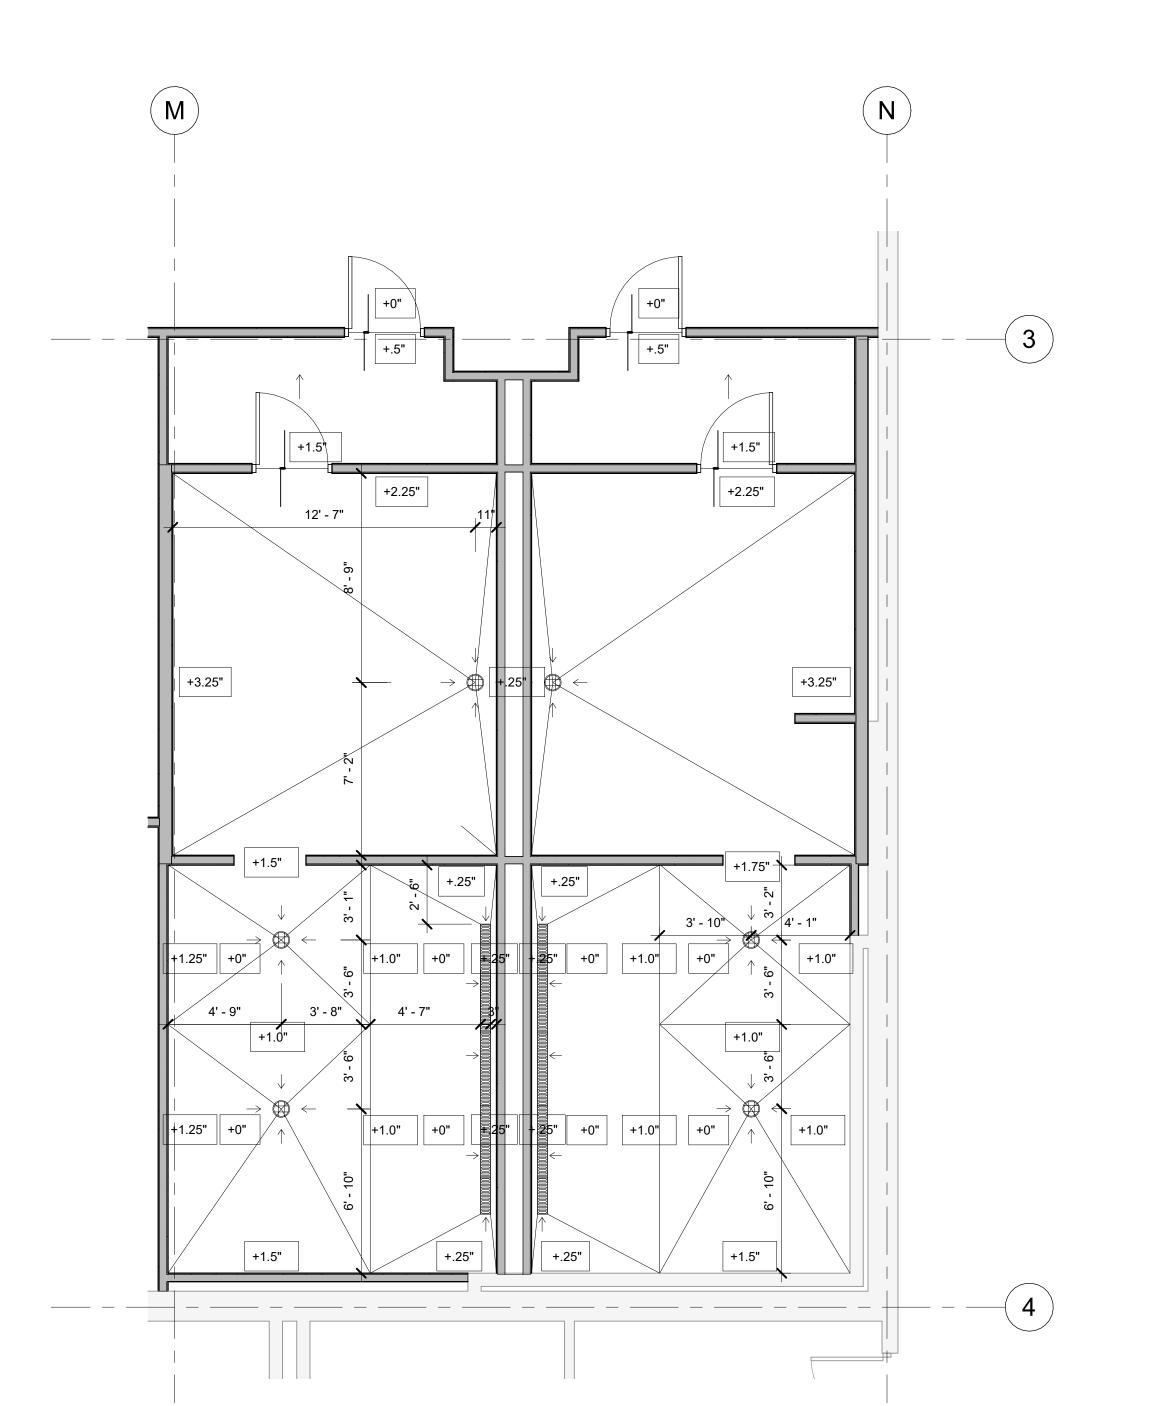

SLOPE DIMENSIONS PLAN OFFICER RR - PHASE 1

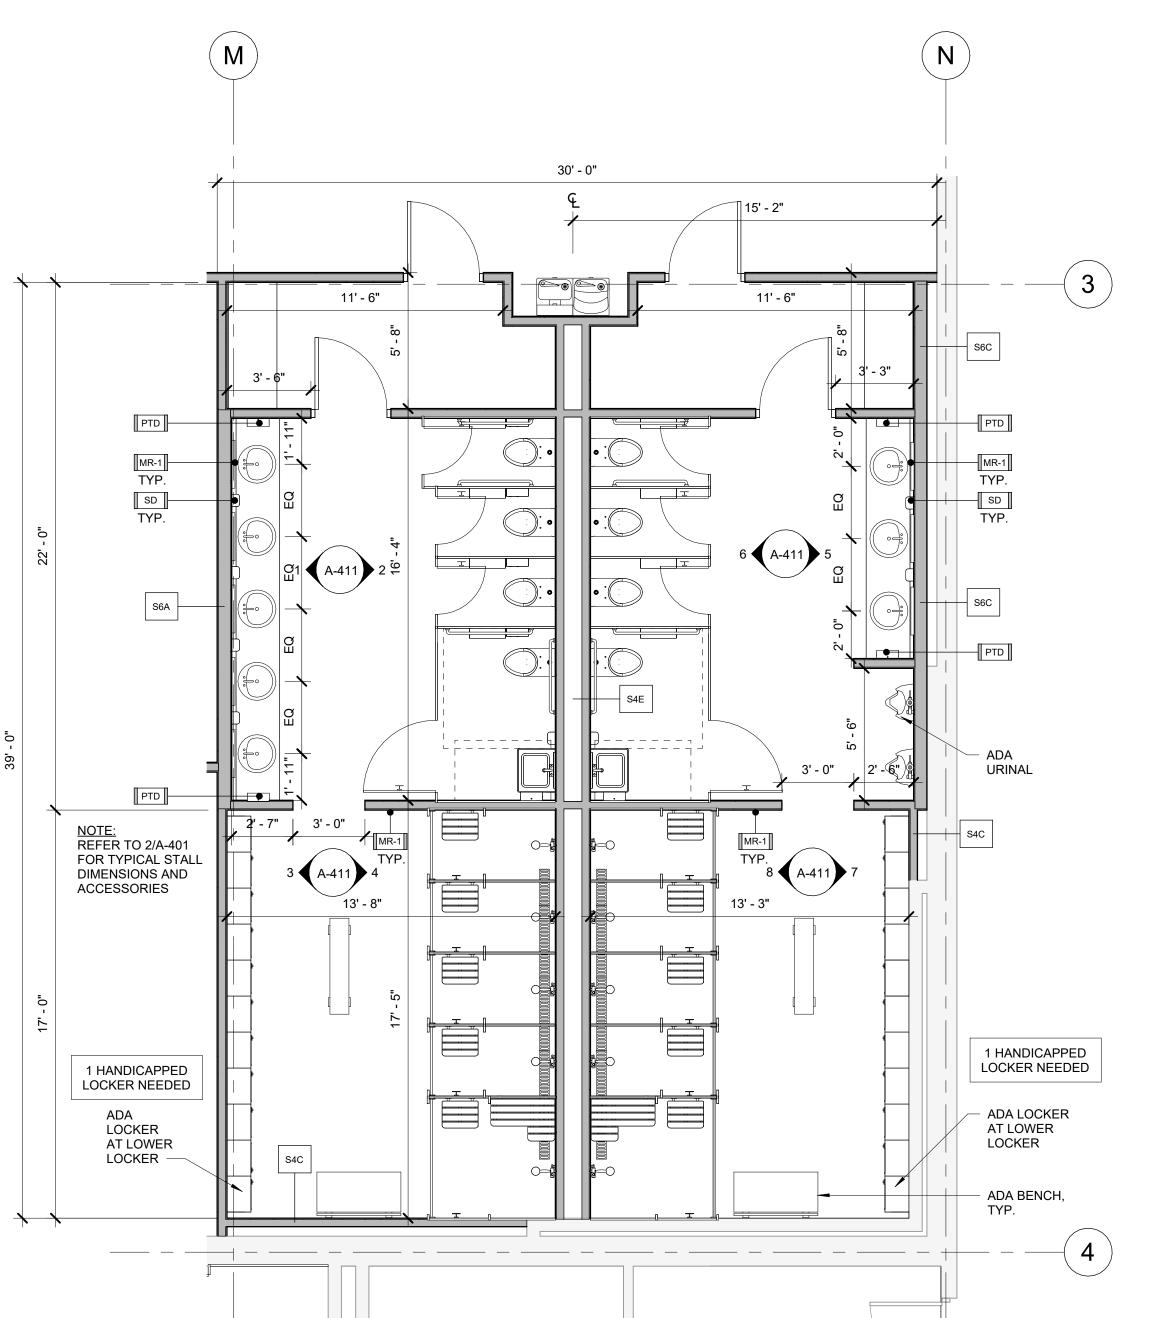

1 DIMENSION PLAN OFFICER RR - PHASE 1

TRAINING ACADEMY
10210 WINDHORST ROAD, TAMPA

Comm. No: 23106.01

Date: 8/15/25

Drawn by: ER

DESIGN PHASE:


Revision
No. Date Description

TO THE BEST OF MY KNOWLEDGE, THE PLAN AND SPECIFICATIONS COMPLY WITH THE MINIMUM BLUI DING CODES



A-401

**ENLARGED PLANS** 

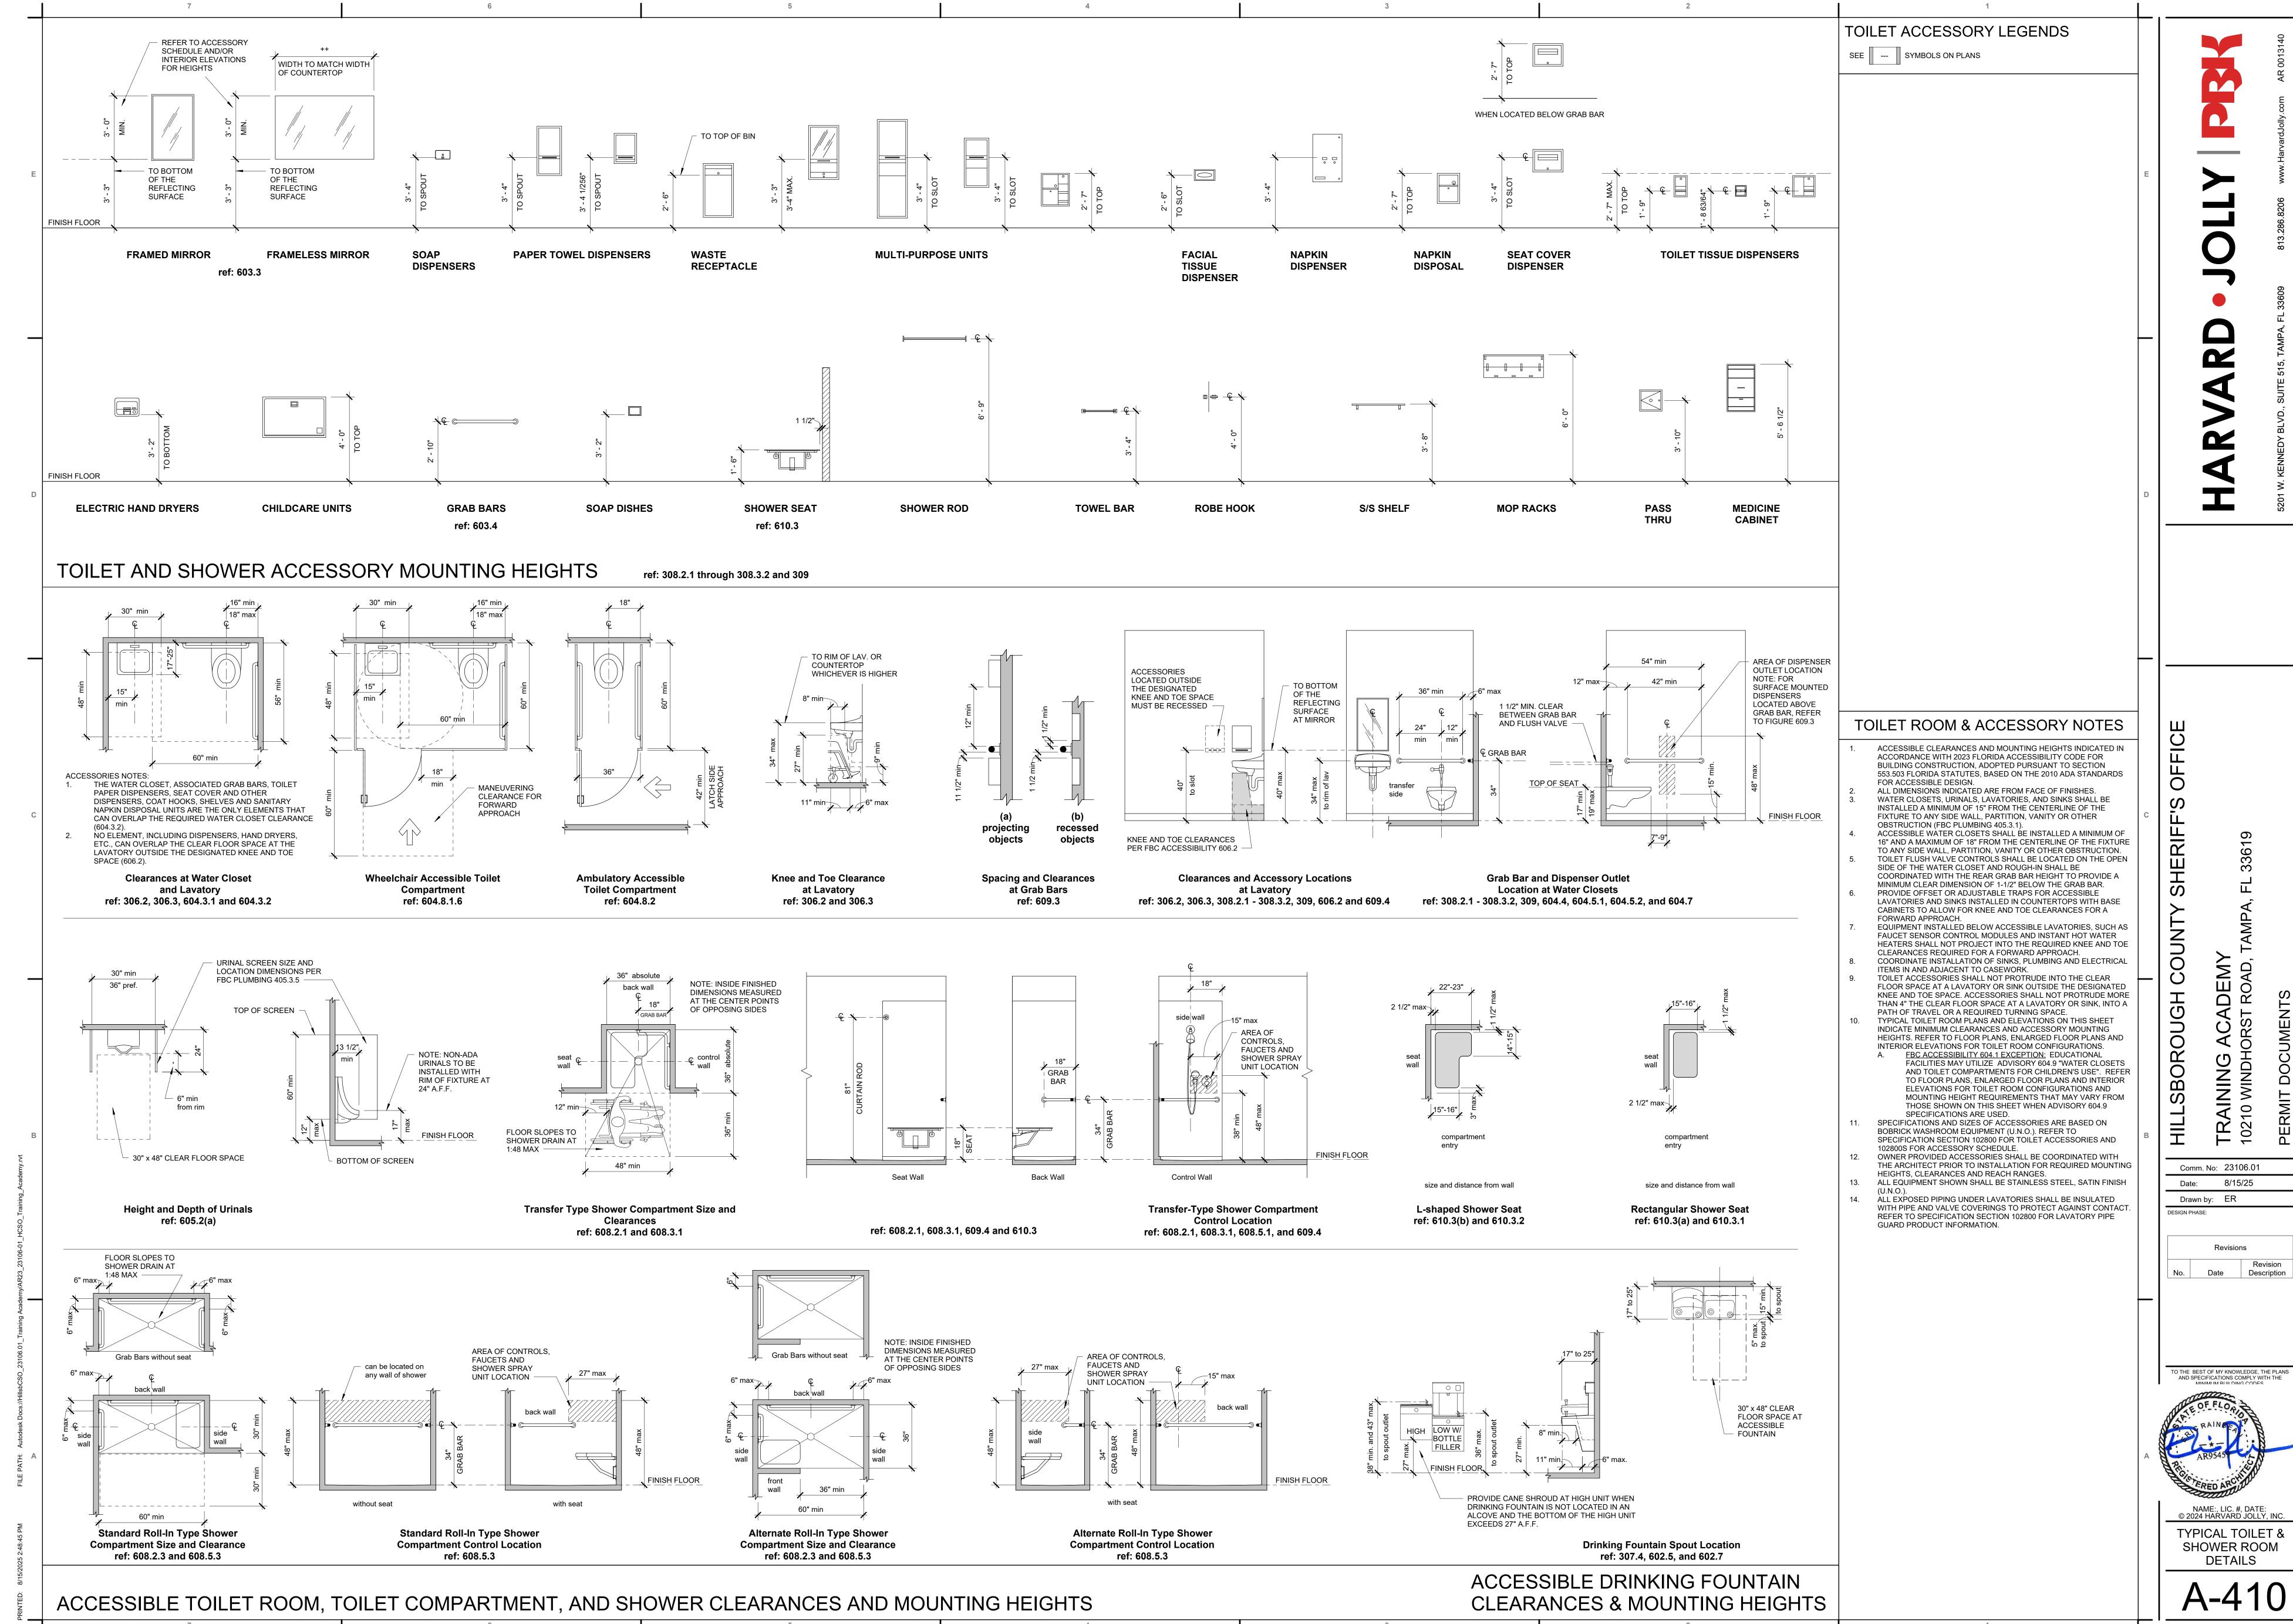

ADE T RO

Comm. No: 23106.01 Date: 8/15/25


Date



**TYPICAL TOILET &** SHOWER ROOM **DETAILS** 

**TOILET ROOM PLANS** ELEVATIONS, & DETAILS

A-411

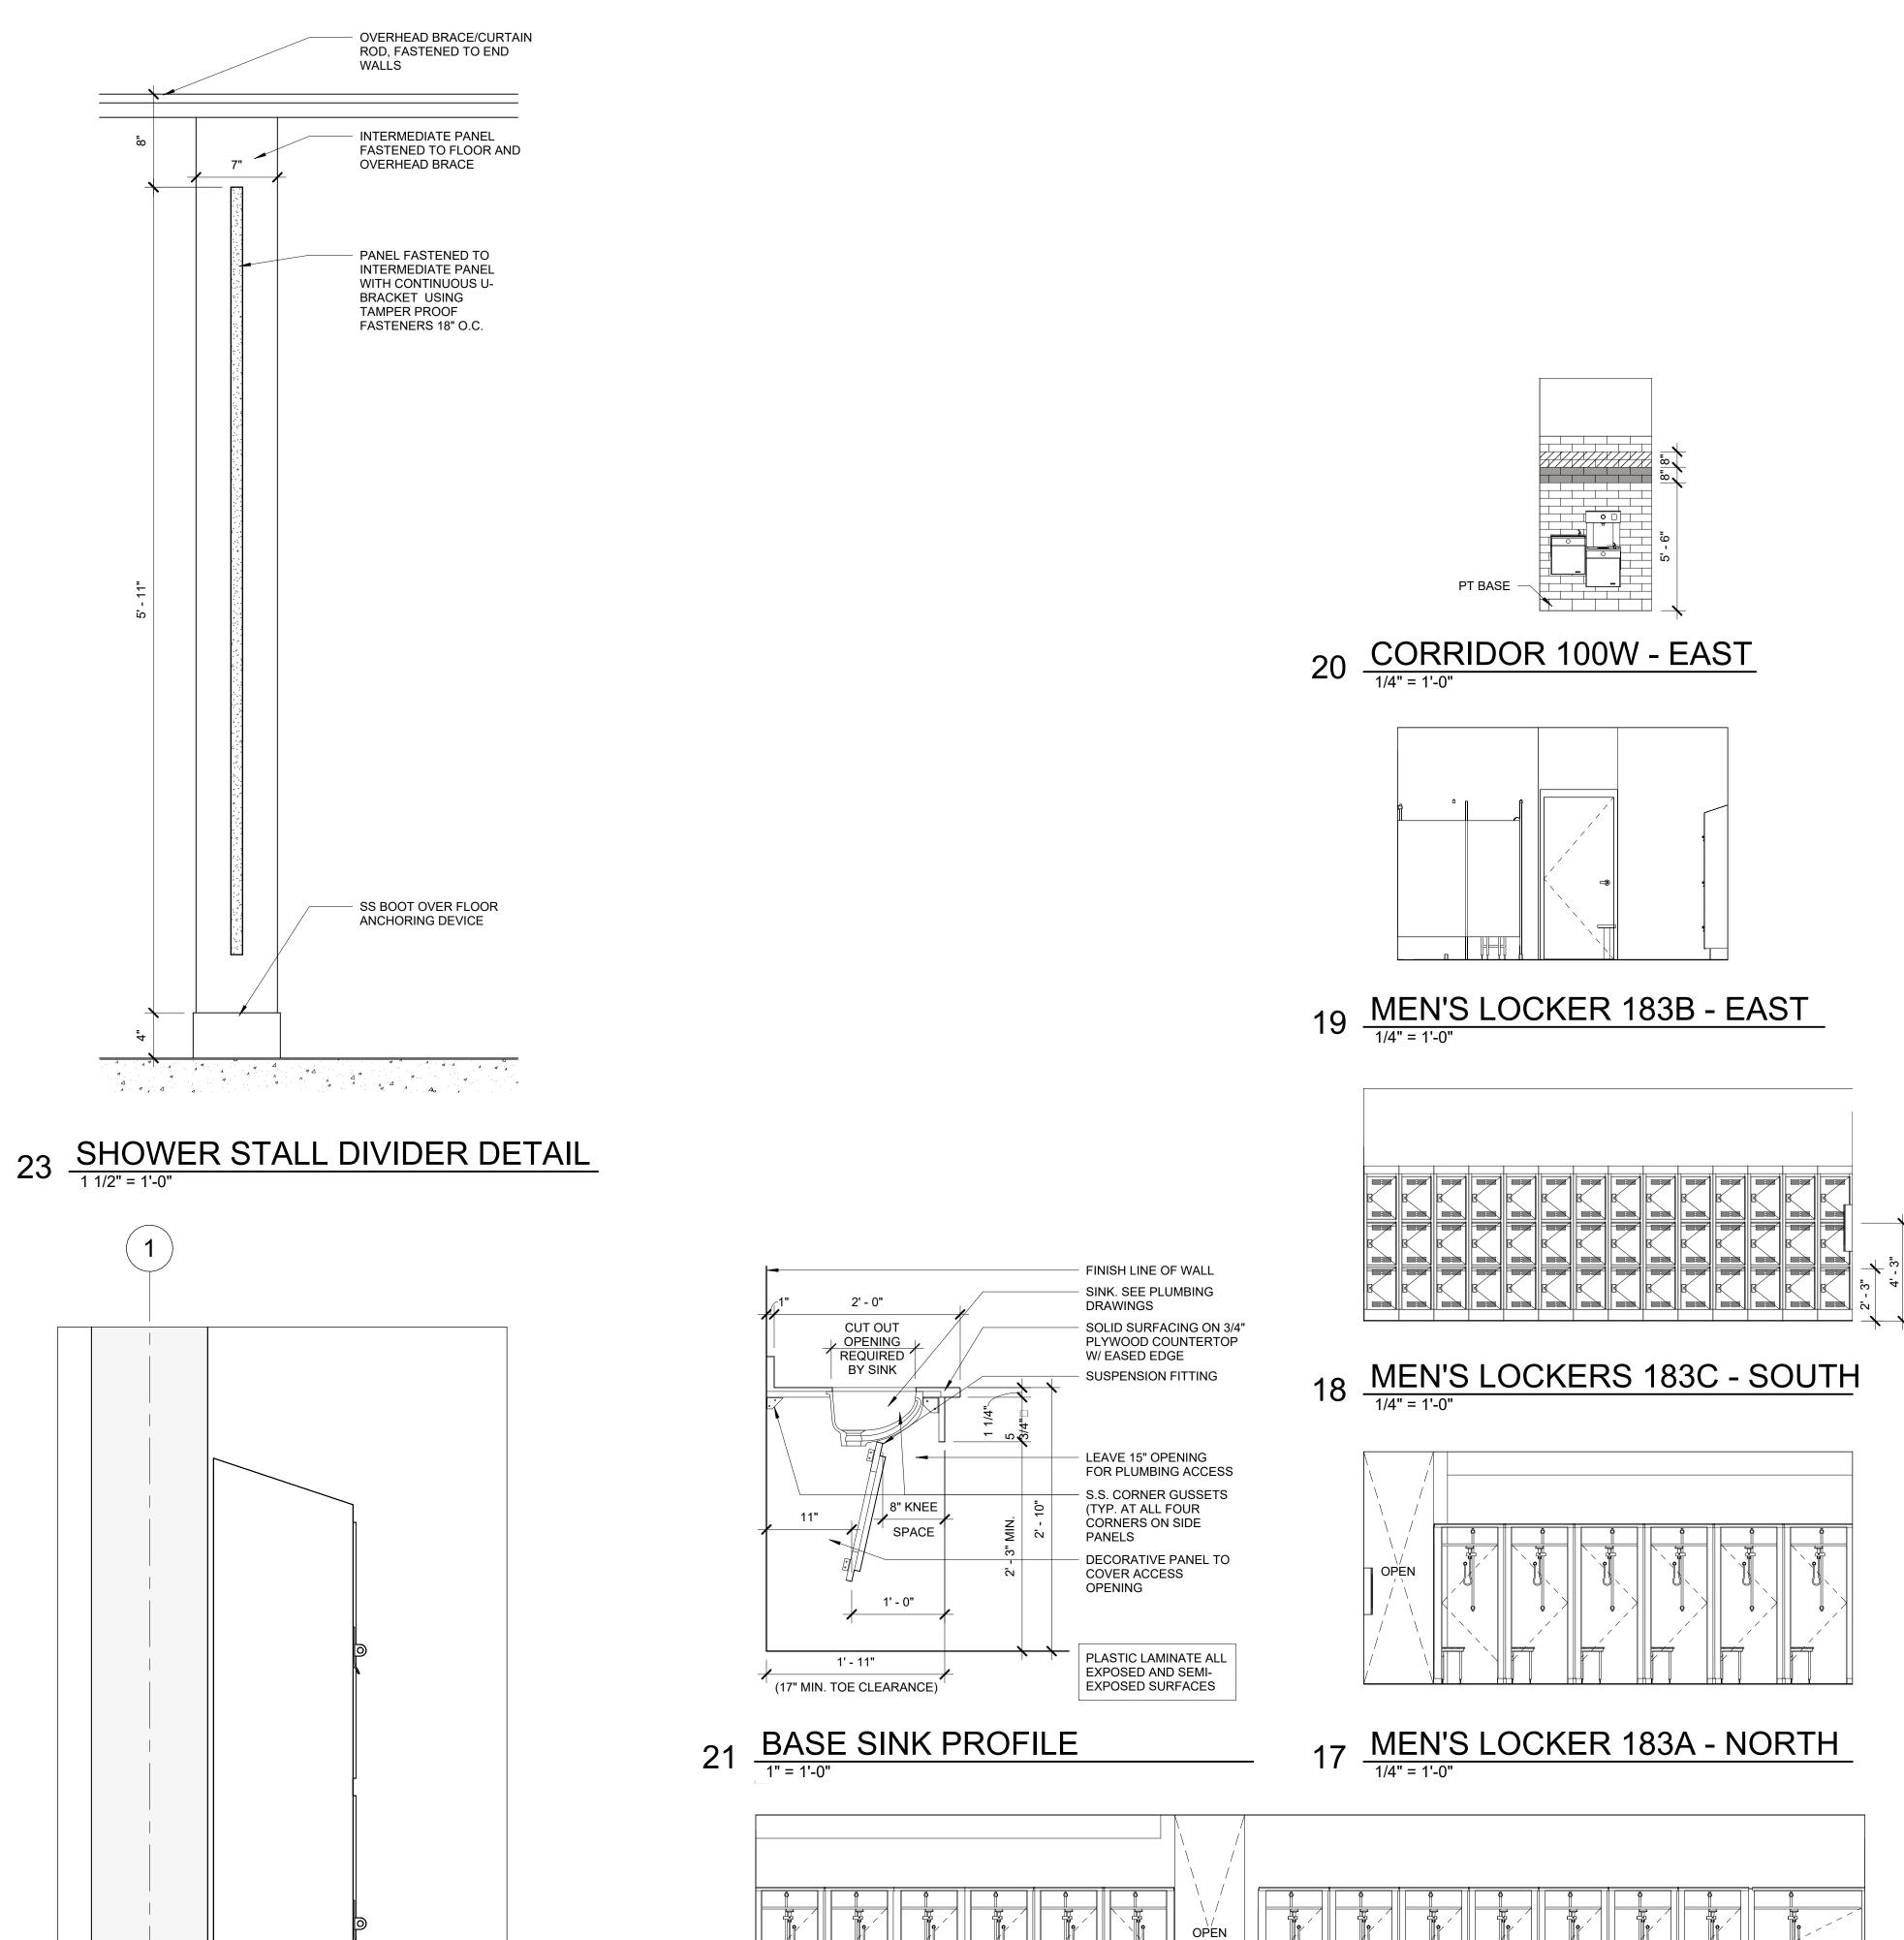

16 MEN'S LOCKERS 183 - SOUTH

15 MEN'S LOCKER 183 - NORTH

6" CMU GROUTED

#3 REBAR

ANCHORED

16" IN N⋢W CONC. FLOOR

SOLID -

/--- WALL TILE BASE


TYPICAL CADET LOCKER


1 1/2" = 1'-0"


FLOORING AS

SCHEDULED


HANDICAPPED LOCKERS

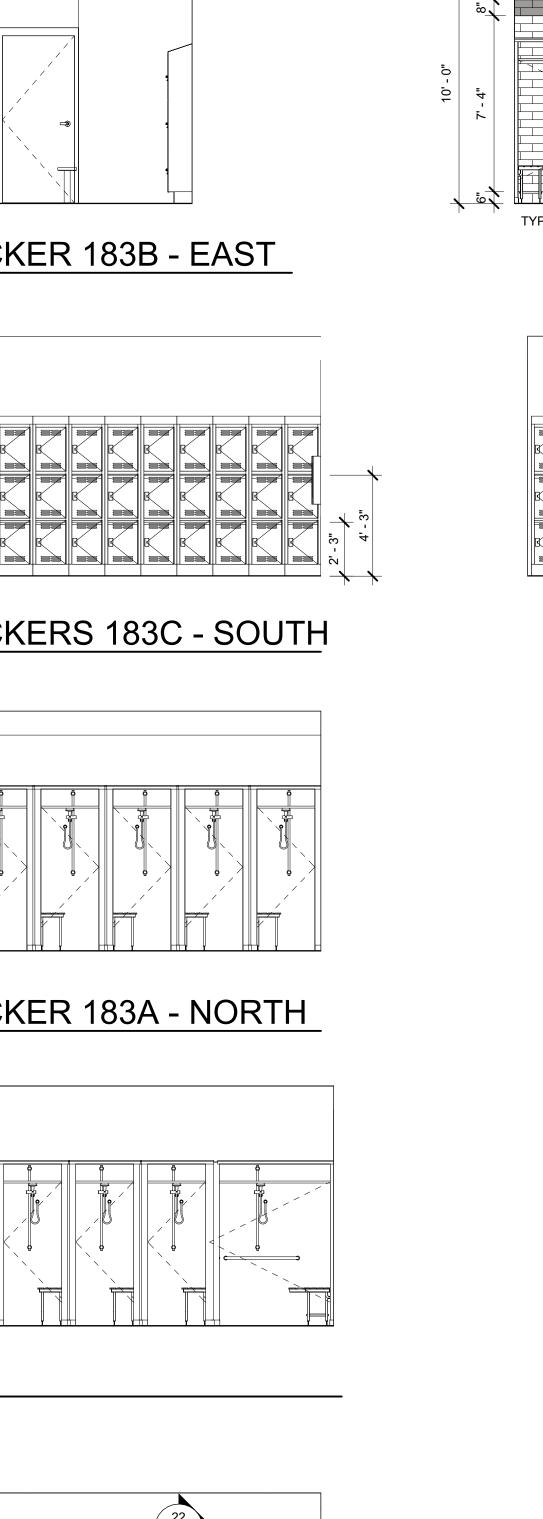

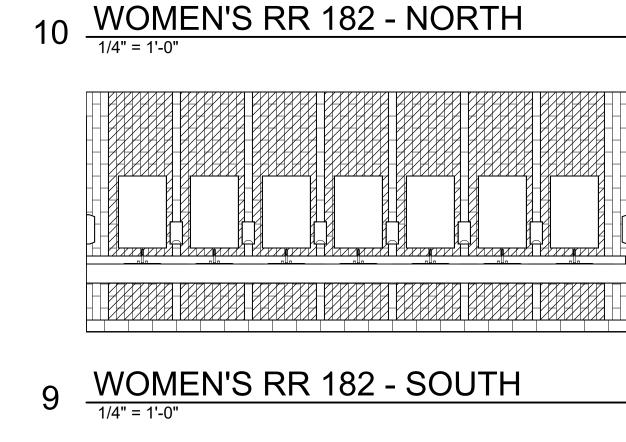

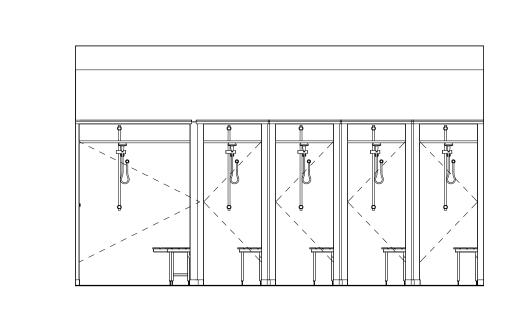


MENS LOCKERS 178 - WEST

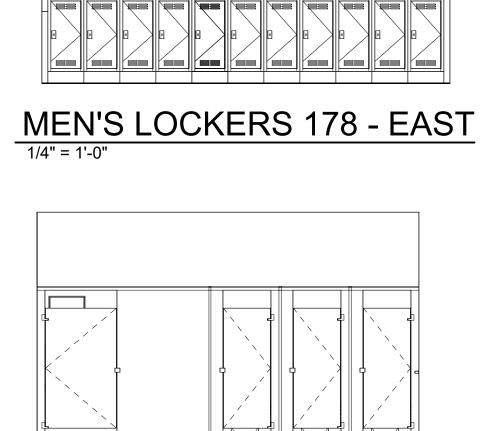




14 MEN'S RR 183 - SOUTH

TYP. WALL TILE PATTERN TO CONTINUE ON ALL WALLS IN NEW AND EXISTING TOILET ROOMS, U.N.O.

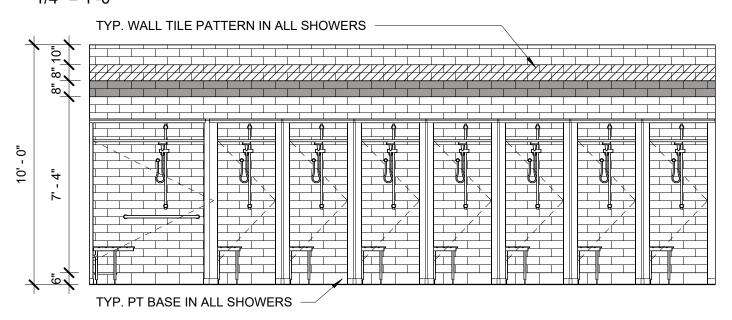



12 WOMEN'S LOCKERS 182 - NORTH

TYP, PT BASE IN ALL TOILET ROOMS

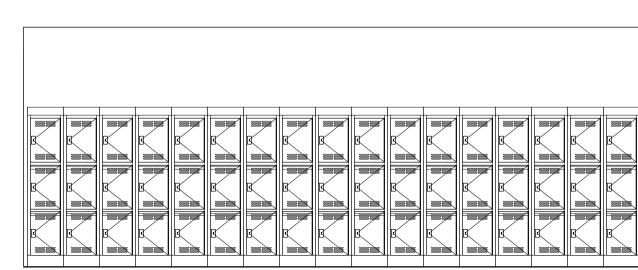

11 WOMEN'S LOCKERS 182 - SOUTH

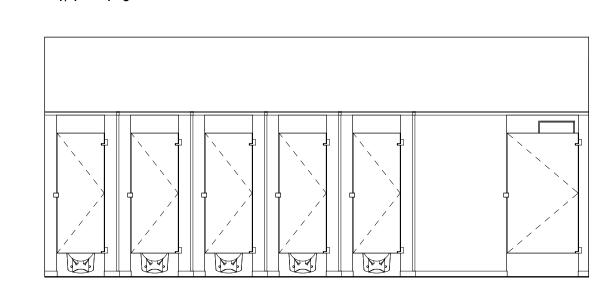

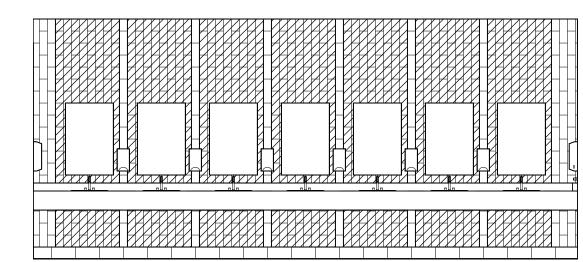

2 WOMEN'S RR 177 - EAST


TYP. PT BASE IN ALL LOCKER ROOMS


3 WOMEN'S LOCKERS 177 - WEST


WOMEN'S RR 177 - WEST


| SCHEE  | DULE - DO           | OR - P | HASE '  | 1       |          |          |       |      |      |           |              |         |
|--------|---------------------|--------|---------|---------|----------|----------|-------|------|------|-----------|--------------|---------|
| DOOR   | DETAILS             |        |         |         |          |          |       |      |      |           |              |         |
| DOOR#  | RATING<br>(MINUTES) | TYPE   | MAT/FIN | GLAZING | WIDTH    | HEIGHT   | FRAME | JAMB | HEAD | THRESHOLD | HDWR.<br>SET | REMARKS |
| EVEL 1 |                     |        |         | •       |          |          | -     |      | •    |           |              |         |
| 100T   | 90                  | В      | HM/L    | FR      | 6' - 0"  | 7' - 0"  | HM/P  |      |      |           | 06           | NOTE 2  |
| 100V.1 |                     | Α      | HM/P    |         | 3' - 0"  | 7' - 0"  |       |      |      |           | 01           | NOTE 4  |
| 100V.2 |                     | Α      | HM/P    |         | 3' - 0"  | 7' - 0"  |       |      |      |           | 01           | NOTE 4  |
| 100W   | 45                  | В      | HW/L    | FR      | 3' - 0"  | 7' - 0"  |       |      |      |           | 13           |         |
| 118    |                     | Α      | HW/L    |         | 4' - 0"  | 7' - 0"  |       |      |      |           | 09           |         |
| 145    |                     | Α      | HW/L    |         | 3' - 0"  | 7' - 0"  |       |      |      |           | 09           |         |
| 169    |                     | Α      | HW/L    |         | 3' - 0"  | 7' - 0"  |       |      |      |           | 14           | PHASE 2 |
| 170A   |                     | Α      | HW/L    |         | 3' - 0"  | 7' - 0"  |       |      |      |           | 14           | PHASE 2 |
| 170B   |                     | Α      | HW/L    |         | 3' - 0"  | 7' - 0"  |       |      |      |           | 14           | PHASE 2 |
| 171A   | 45                  | В      | HW/L    | FR      | 3' - 0"  | 7' - 0"  |       |      |      |           | 03           |         |
| 171B   | 45                  | В      | HW/L    | FR      | 3' - 0"  | 7' - 0"  |       |      |      |           | 03           |         |
| 171C   |                     | Α      | HM/P    |         | 3' - 0"  | 7' - 0"  |       |      |      |           | 01           | NOTE 5  |
| 172    | 45                  | Α      | HW/L    |         | 6' - 0"  | 7' - 0"  |       |      |      |           | 05           |         |
| 173    |                     | Α      | HW/L    |         | 3' - 0"  | 7' - 0"  |       |      |      |           | 12           | PHASE 2 |
| 174    |                     | Α      | HW/L    |         | 6' - 0"  | 7' - 0"  |       |      |      |           | 05           |         |
| 175A   | 45                  | В      | HW/L    | FR      | 6' - 0"  | 7' - 0"  |       |      |      |           | 05           | NOTE 1  |
| 175B   |                     | E      | HM/P    |         | 3' - 0"  | 7' - 0"  |       |      |      |           | 01           |         |
| 175C   |                     | E      | HM/P    |         | 3' - 0"  | 7' - 0"  |       |      |      |           | 02           |         |
| 176    |                     | E      | HW/L    |         | 3' - 0"  | 7' - 0"  |       |      |      |           | 10           |         |
| 177A   |                     | Α      | HW/L    |         | 3' - 0"  | 7' - 0"  |       |      |      |           | 14           |         |
| 177B   |                     | Α      | HW/L    |         | 3' - 0"  | 7' - 0"  |       |      |      |           | 14           |         |
| 178A   |                     | A      | HW/L    |         | 3' - 0"  | 7' - 0"  |       |      |      |           | 14           |         |
| 178B   |                     | Α      | HW/L    |         | 3' - 0"  | 7' - 0"  |       |      |      |           | 14           |         |
| 179A   | 45                  | В      | HW/L    | FR      | 3' - 0"  | 7' - 0"  |       |      |      |           | 11           |         |
| 179B   |                     |        | AL/P    |         | 10' - 0" | 14' - 0" |       |      |      |           | 15           | NOTE 3  |
| 180(E) |                     | Α      | HM/P    |         | 3' - 0"  | 7' - 0"  |       |      |      |           | 12           |         |
| 181A   |                     | Α      | HM/P    |         | 6' - 0"  | 7' - 0"  |       |      |      |           | 07           |         |
| 182A   |                     | A      | HW/L    |         | 3' - 0"  | 7' - 0"  |       |      |      |           | 14           |         |
| 182B   |                     | Α      | HW/L    |         | 3' - 0"  | 7' - 0"  |       |      |      |           | 14           |         |
| 182C   |                     | A      | HW/L    |         | 3' - 0"  | 7' - 0"  |       |      |      |           | 12           |         |
| 183A   |                     | A      | HW/L    |         | 3' - 0"  | 7' - 0"  |       |      |      |           | 14           |         |
| 183B   |                     | A      | HM/P    |         | 3' - 0"  | 7' - 0"  |       |      |      |           | 03           | NOTE 6  |
| 202    |                     | Α      | HM/P    |         | 3' - 0"  | 7' - 0"  |       |      |      |           | 04           |         |


1. PROVIDE DOOR AS SCHEDULED ONLY IF ADD ALTERNATE 2 IS CHOSEN. IN THE BASE BID DOOR IS TO BE TYPE A- HW/L. 2. HM/L LAMINATE TO MATCH HW/L LAMINATE. 3. EXISTING OVERHEAD DOOR TO BE ISO 8501 SA1 CLEANED AND PAINTED.

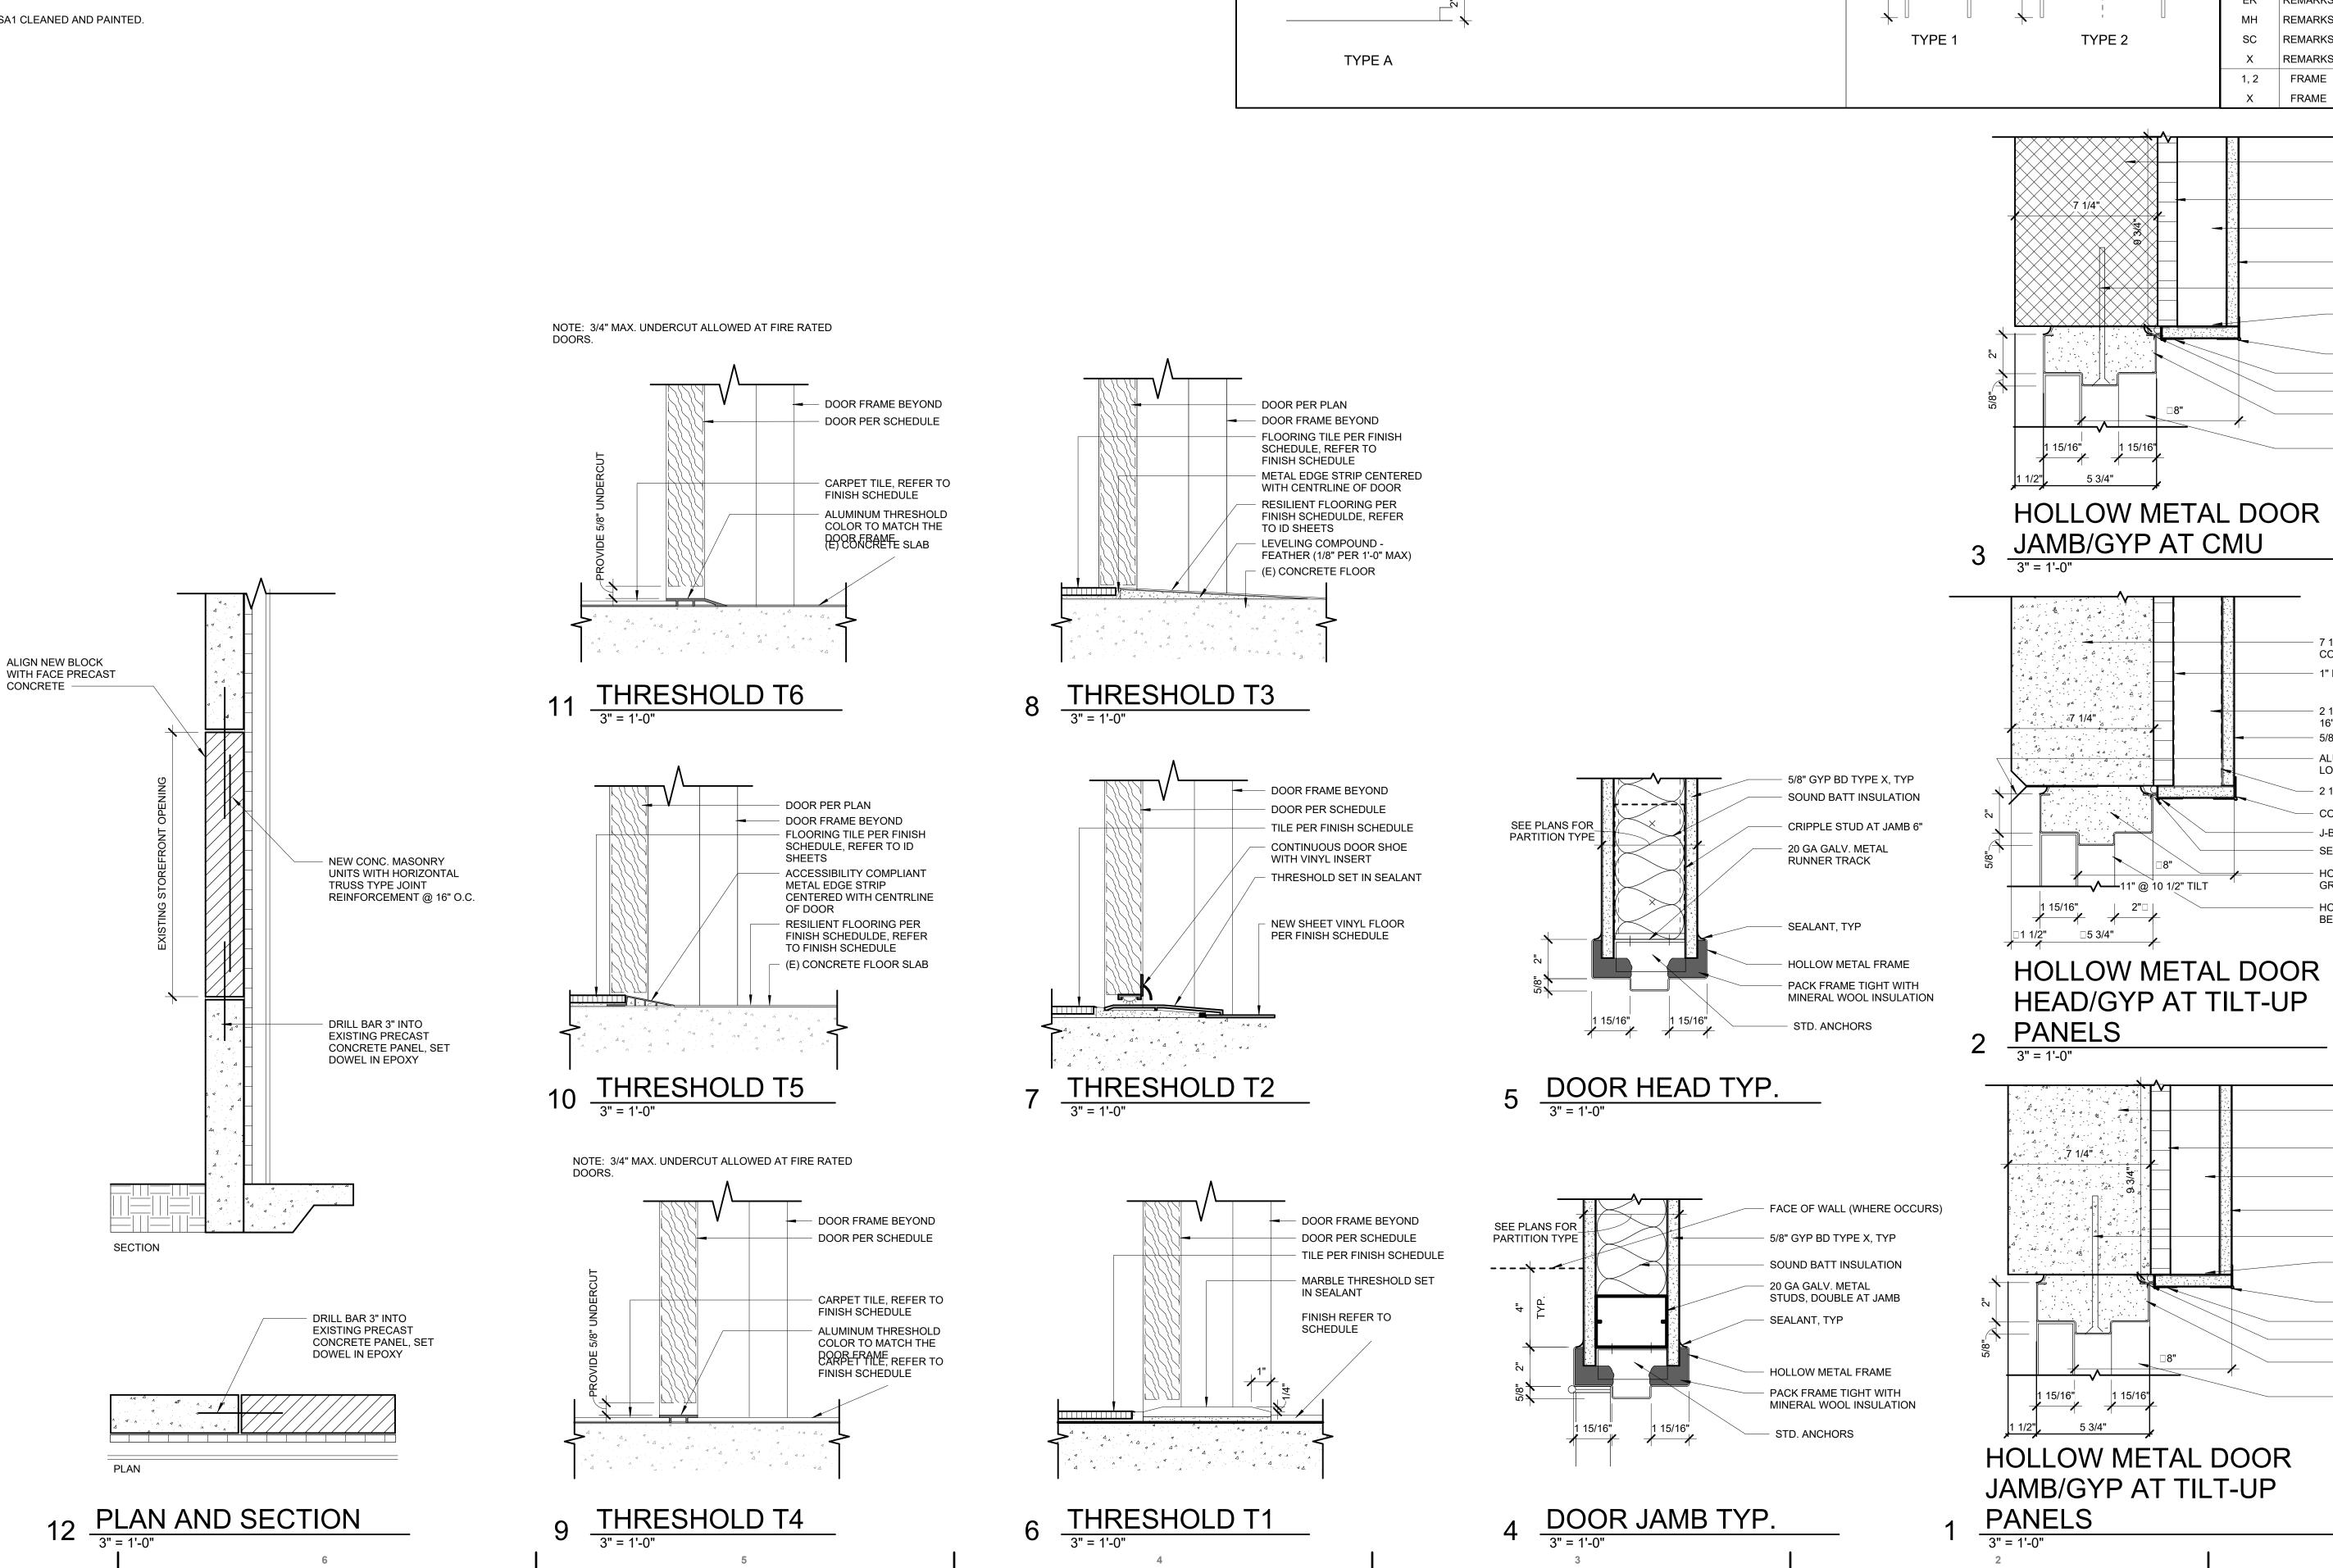

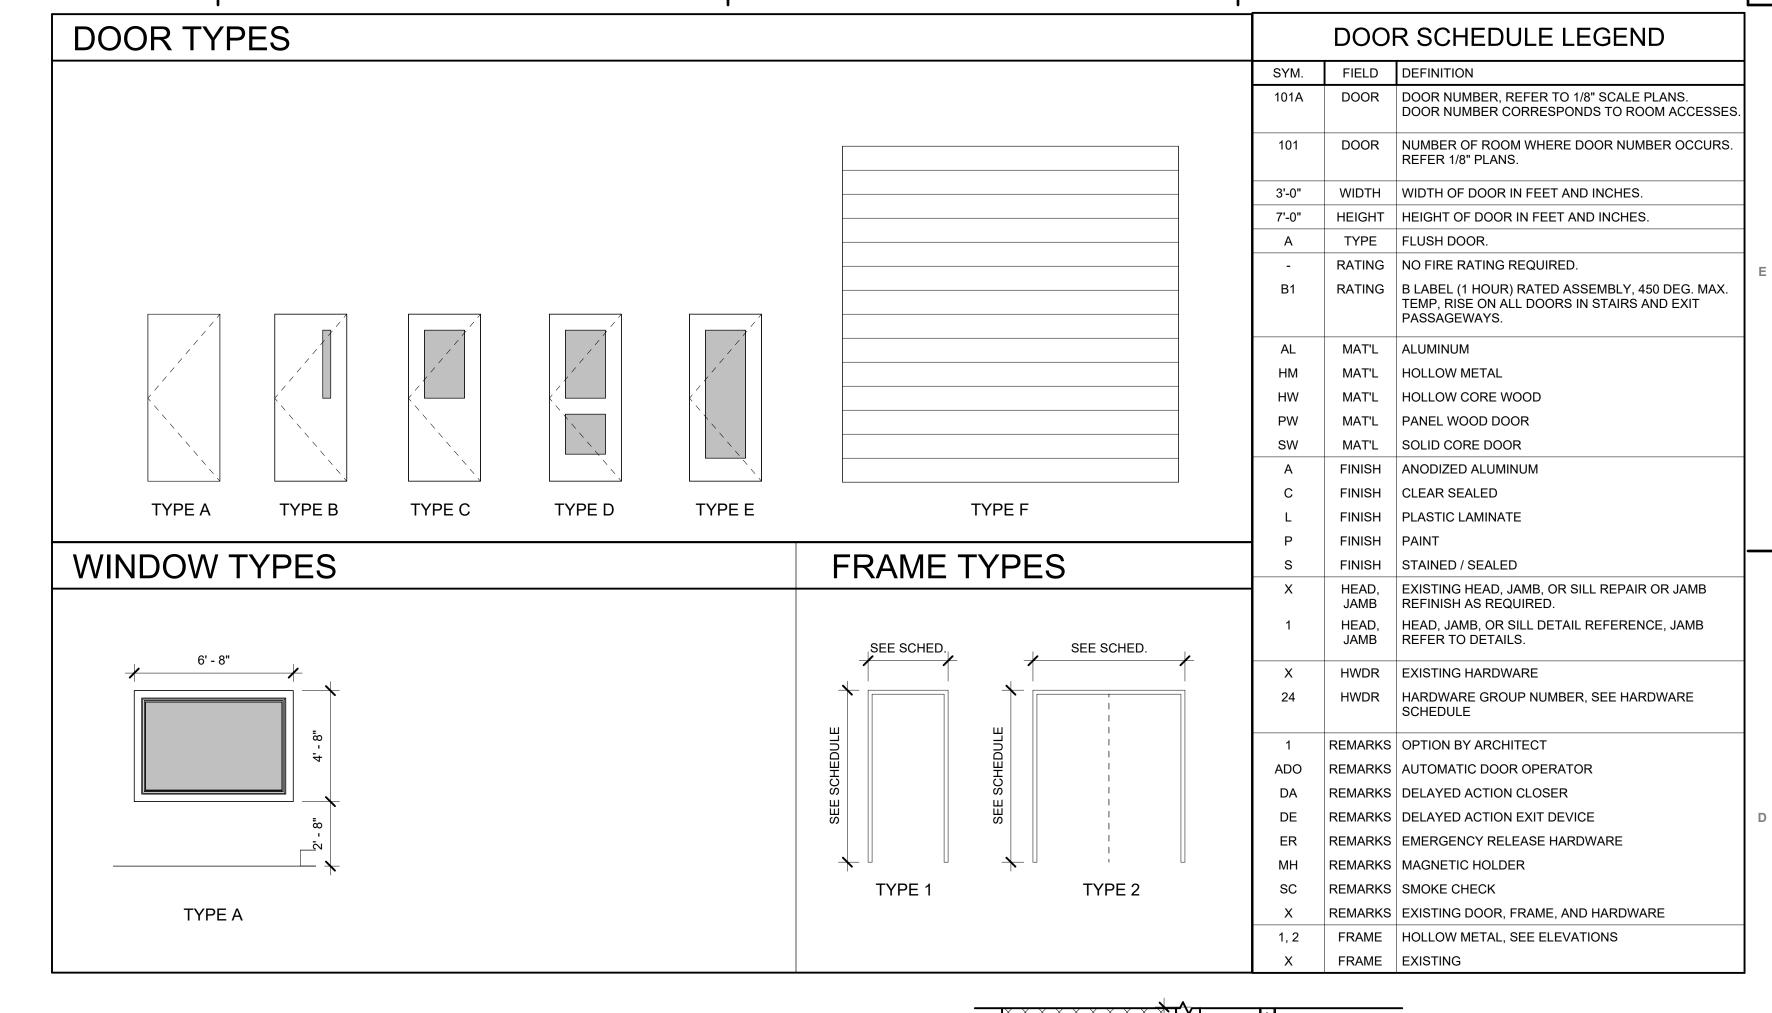

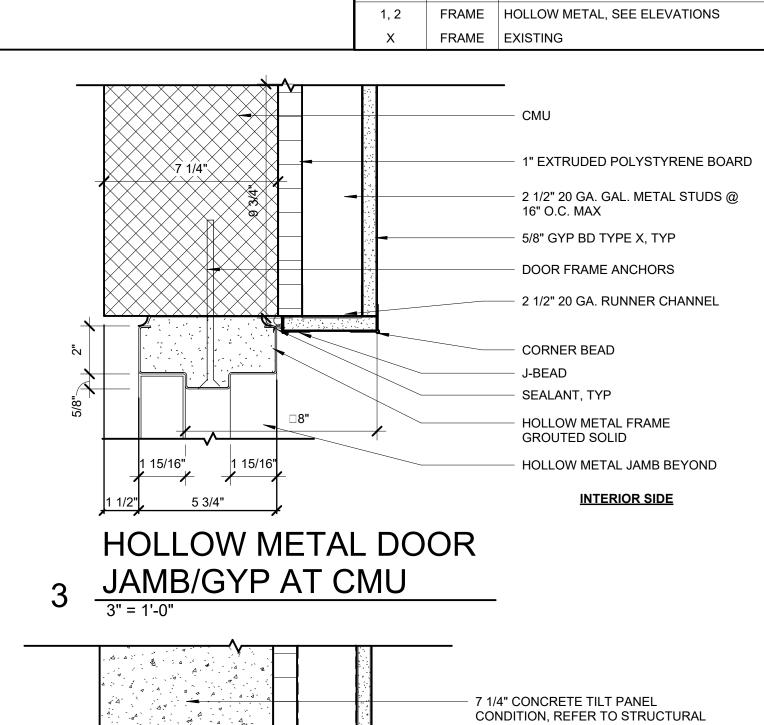

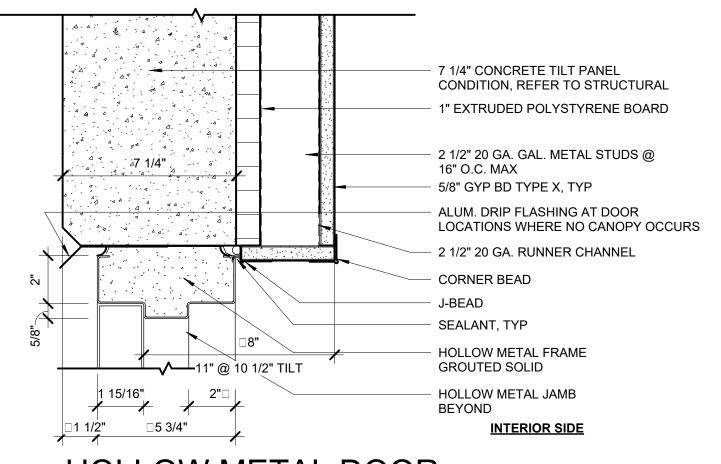

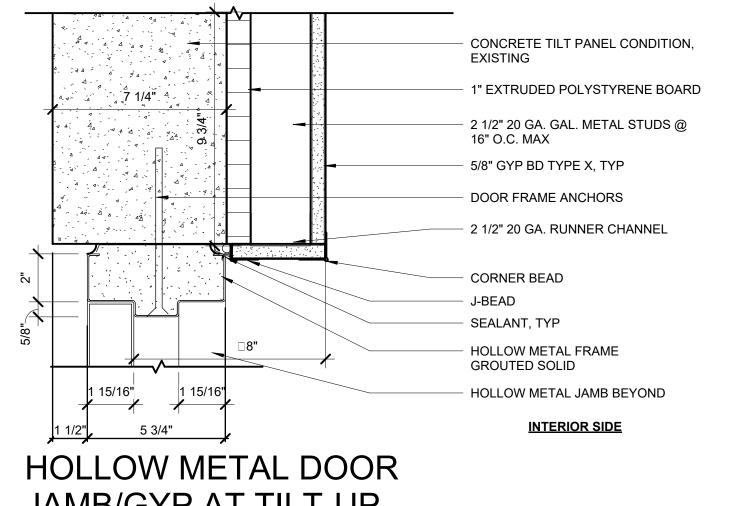

TO THE BEST OF MY KNOWLEDGE, THE PLANS AND SPECIFICATIONS COMPLY WITH THE

OF

HERIFF

COUNT

SBOROUGH

ADEMY ST ROAD, "

TRAINING 10210 WINDH

Comm. No: 23106.01

Date: 8/15/25

Date


Revisions

Drawn by: ER

NAME:, LIC. #, DATE: © 2024 HARVARD JOLLY, INC. DOOR SCHEDULES, ELEVATIONS, LEGENDS, & NOTES


|          |                                 |          | FINISH | SCHEDULE | - FIRST FL | OOR   |         |            |          |
|----------|---------------------------------|----------|--------|----------|------------|-------|---------|------------|----------|
|          |                                 | OR       |        | W        | ALLS       |       | CEILING |            |          |
| ROOM NO. | ROOM NAME                       | FINISH   | BASE   | NORTH    | EAST       | SOUTH | WEST    | FINISH     | REMARKS  |
| _EVEL 1  |                                 |          |        |          |            |       |         |            |          |
| 100T     | CORRIDOR                        | LVT      | RC     | P1       | P1         | P1    | P1      | ACT-1      | 1        |
| 100U     | CORRIDOR                        | LVT      | RC     | P1       | P1         | P1    | P1      | ACT-1      | 1        |
| 100V     | CORRIDOR                        | LVT/WM   | RC     | P1       | P1         | P1    | P1      | ACT-1      | 1        |
| 100W     | CORRIDOR                        | PT       | PT     | P1       | P1/CT      | P1    | P1      | ACT-1      | 5        |
| 118      | IDF RM                          | SC       | RC     | P1       | P1         | P1    | P1      | ACT-1      |          |
| 144      | AUDIOVISUAL EQUIP.              | SC       | RC     | P1       | P1         | P1    | P1      | ACT-1      |          |
| 145      | MDF RM                          | SC       | RC     | P1       | P1         | P1    | P1      | ACT-1      |          |
| 167      | STORAGE                         | SC       | RC     | P1       | P1         | P1    | P1      | ACT-1      |          |
| 168      | MDF ROOM                        | SC       | RC     | P1       | P1         | P1    | P1      | ACT-1      |          |
| 171      | MAT ROOM 1                      | LVT1     | RC     | P1       | P2         | P1    | P1      | ACT-1      |          |
| 172      | MAT STORAGE                     | LVT1     | RC     | P1       | P1         | P1    | P1      | ACT-1      |          |
| 174      | GYM STORAGE                     | LVT1     | RC     | P1       | P1         | P1    | P1      | ACT-1      |          |
| 175      | GYM                             | RS/WM    | RC     | P3       | P1         | P1    | P1      | EXPOSED/PT | 1,4,5, 7 |
| 176      | OFFICE                          | LVT1     | RB     | P1       | P1         | P1    | P1      | ACT-1      |          |
| 177      | WOMENS RESTROOM SHOWERS/LOCKERS | PT/MT    | PT/CT  | СТ       | СТ         | СТ    | СТ      | ACT-2/GYP  | 2,3      |
| 178      | MENS RESTROOM SHOWERS/LOCKERS   | PT/MT    | PT/CT  | СТ       | СТ         | СТ    | СТ      | ACT-2/GYP  | 2,3      |
| 179      | LOADING                         | SC       | RC     | P1       | P1         | P1    | P1      | ACT-1      |          |
| 180      | ELECT. RM                       | SC       | RC     | P1       | P1         | P1    | P1      | ACT-1      |          |
| 181      | STORAGE                         | SC       | RC     | P1       | P1         | P1    | P1      | ACT-1      |          |
| 181A     | UTIL.                           | SC       | RC     | P1       | P1         | P1    | P1      | ACT-1      |          |
| 182      | WOMENS RESTROOM SHOWERS/LOCKERS | PT/MT    | PT     | СТ       | СТ         | СТ    | СТ      | ACT-2/GYP  | 2,3      |
| 182C     | JAN                             | PT       | PT     | P1/FRP   | P1/FRP     | P1    | P1      | ACT-2      | 6        |
| 183      | MENS RESTROOM SHOWERS/LOCKERS   | PT/MT/WM | PT     | СТ       | CT         | CT    | CT      | ACT-2/GYP  | 1,2,3,4  |
| 202      | RISER ROOM                      | SC       | RB     | EP1      | EP1        | EP1   | EP1     | ACT-1      |          |

| FINISH SCHEDULE - FIRST FLOOR   FINISH   SCHEDULE - FIRST FLOOR   FROM NO.   ROOM NAME   FINISH   SAST   NORTH   SAST   SOUTH   WEST   FINISH   REMARKS   FINISH   SOUTH   WEST   FINISH   WEST   FINISH   SOUTH   WEST   FINISH   WEST   FINISH   SOUTH   WEST   FINISH   WEST   W   | FINISH MATERIAL LEGEND  FLOORING  A. LUXURY VINYL TILE  1. LVT1 MANUFACTURER: COLLECTION: STYLE: 1559V COLOR: SPROUT 00173 SIZE: 1596" X 48" (5MM THICKNESS) BRICK  2. LVT2 MANUFACTURER: COLLECTION: STYLE: 1559V COLOR: ARBOR 00360 SIZE: INSTALLATION: BRICK  B. RUBBER SHEET FLOOR  1. RS MANUFACTURER: PATCRAFT TIMBER GROVE II 1559V COLOR: ARBOR 00360 SIZE: INSTALLATION: BRICK  B. RUBBER SHEET FLOOR  1. RS MANUFACTURER: PRODUCT: COLOR: SPORT 1MPACT COLOR: SOUTH MEDIUM GREY 10MM  C. PORCELAIN TILE  1. PT MANUFACTURER: PRODUCT: COLOR: BREZZE S33' SIZE: 18TANDS COLOR: BREZZE S33' 12" X 24" SIZE: 18TANDS COLOR: BREZZE S33' SIZE: 3" X 3" (12" X 12"  | FINISHES SCHEDULE LEGEND  SYMBOL FIELD DEFINITION  X FLOOR EXISTING TO REMAIN LVT FLOOR MOSAIC FLOOR TILE PT FLOOR MOSAIC FLOOR TILE PT FLOOR PORCELAIN TILE SC FLOOR SEALED CONCRETE WM FLOOR WALK-OFF CARPET  X BASE EXISTING TO REMAIN  | HARVARD JOLLY PRES  5201 W. KENNEDY BLVD., SUITE 515, TAMPA, FL 33609  813.286.8206 www.HarvardJolly.com AR 0013140  |
|--|--|--|--|
|  | MALLS  A. PAINT 1. P1 MANUFACTURER: SHERWIN WILLIAMS SW 7008 ALABASTER OCLOR: SW 7017 DORIAN GRAY LOCATION: OVERALL PAINT  2. P2 MANUFACTURER: SHERWIN WILLIAMS SW 7008 ALABASTER OCLOR: SW 7017 DORIAN GRAY LOCATION: ACCENT PAINT  4. EP1 MANUFACTURER: SHERWIN WILLIAMS SW 6447 EVERGREENS LOCATION: ACCENT PAINT  4. EP1 MANUFACTURER: SHERWIN WILLIAMS SW 6447 EVERGREENS ACCENT PAINT  4. EP1 MANUFACTURER: SHERWIN WILLIAMS SW 7008 ALABASTER  B. CERAMIC TILE 1. CT1 MANUFACTURER: SHERWIN WILLIAMS SW 7008 ALABASTER  B. CERAMIC TILE 2. CT2 MANUFACTURER: PRODUCT: COLOR: ICE WHITE 0025 SIZE: 4" X 12" INSTALLATION: 1/2 OFFSET  3. CT3 MANUFACTURER: PRODUCT: COLOR STORY WALL DEPENDABLE 0053 SIZE: 4" X 12" INSTALLATION: 1/2 OFFSET  3. CT3 MANUFACTURER: PRODUCT: COLOR: STORY WALL OCLOR STORY WALL | FINISH SCHEDULE REMARKS  1. REFER TO INTERIOR DESIGN DRAWINGS FOR FLOOR PATTERNS LOCATIONS. 2. REFER TO SHEET A-411 FOR WALL TILE PATTERNS IN TOILET ROOMS/SHOWERS/LOCKER ROOMS. 3. ALL SHOWERS TO RECEIVE MOSAIC FLOOR TILE. 4. WALK-OFF CARPET AT ENTRANCES FROM EXTERIOR. 5. WALL BEHIND WATER FOUNTAINS TO RECEIVE WALL TILE, SEE DRAWINGS FOR LOCATIONS. 6. 4' W X 4' H FRP PANELS TO BE INSTALLED ON THE WALL BEHIND AND BESIDE MOP SINK ABOVE THE COVE BASE TILE. 7. PAINT ALL EXPOSED SURFACES AND STRUCTURE BLACK ABOVE 11'-0".   | HILLSBOROUGH COUNTY SHERIFF'S OFFICE  FRAINING ACADEMY  10210 WINDHORST ROAD, TAMPA, FL 33619  PERMIT DOCUMENTS  |
| To provide the second of the property of the provided of the p |  | GENERAL FINISH NOTES  1. REFER TO SPECIFICATIONS IN PROJECT MANUAL, ID SHEETS, FINISH SCHEDULES, AND INTERIOR ELEVATIONS FOR ADDITIONAL AND SPECIFIC INFORMATION ON MATERIALS, FINISH TYPES, PATTERNS, COLOR SELECTIONS, LOCATIONS AND DIMENSIONS.  2. REFER TO ID SHEETS FOR FLOOR PATTERNS, PAINT, AND ACCENT PAINT LOCATIONS.  3. FINISH FLOORING SHALL EXTEND UNDER ALL CASEWORK.  4. LOCATE CHANGES IN FLOOR FINISHES AT CENTERLINE OF DOOR, U.N.O.  5. PAINT SHALL BE P1 UNLESS OTHERWISE NOTED.  6. ALL GYPSUM WALLBOARD CEILINGS SHALL BE PAINTED.  7. REFER TO REFLECTED CEILING PLANS FOR LOCATIONS AND SIZES OF PAINTED GYPSUM WALLBOARD SOFFITS AND BULKHEADS. | Comm. No: 23106.01  Date: 8/15/25  Drawn by: ER  DESIGN PHASE:  Revisions  No. Date Revision  Description  TO THE BEST OF MY KNOWLEDGE, THE PLANS AND SPECIFICATIONS COMPLY WITH THE  MINIMAL IN PLANS AR9545  NAME:, LIC. #, DATE: © 2024 HARVARD JOLLY, INC.  FINISH SCHEDULES AND NOTES |

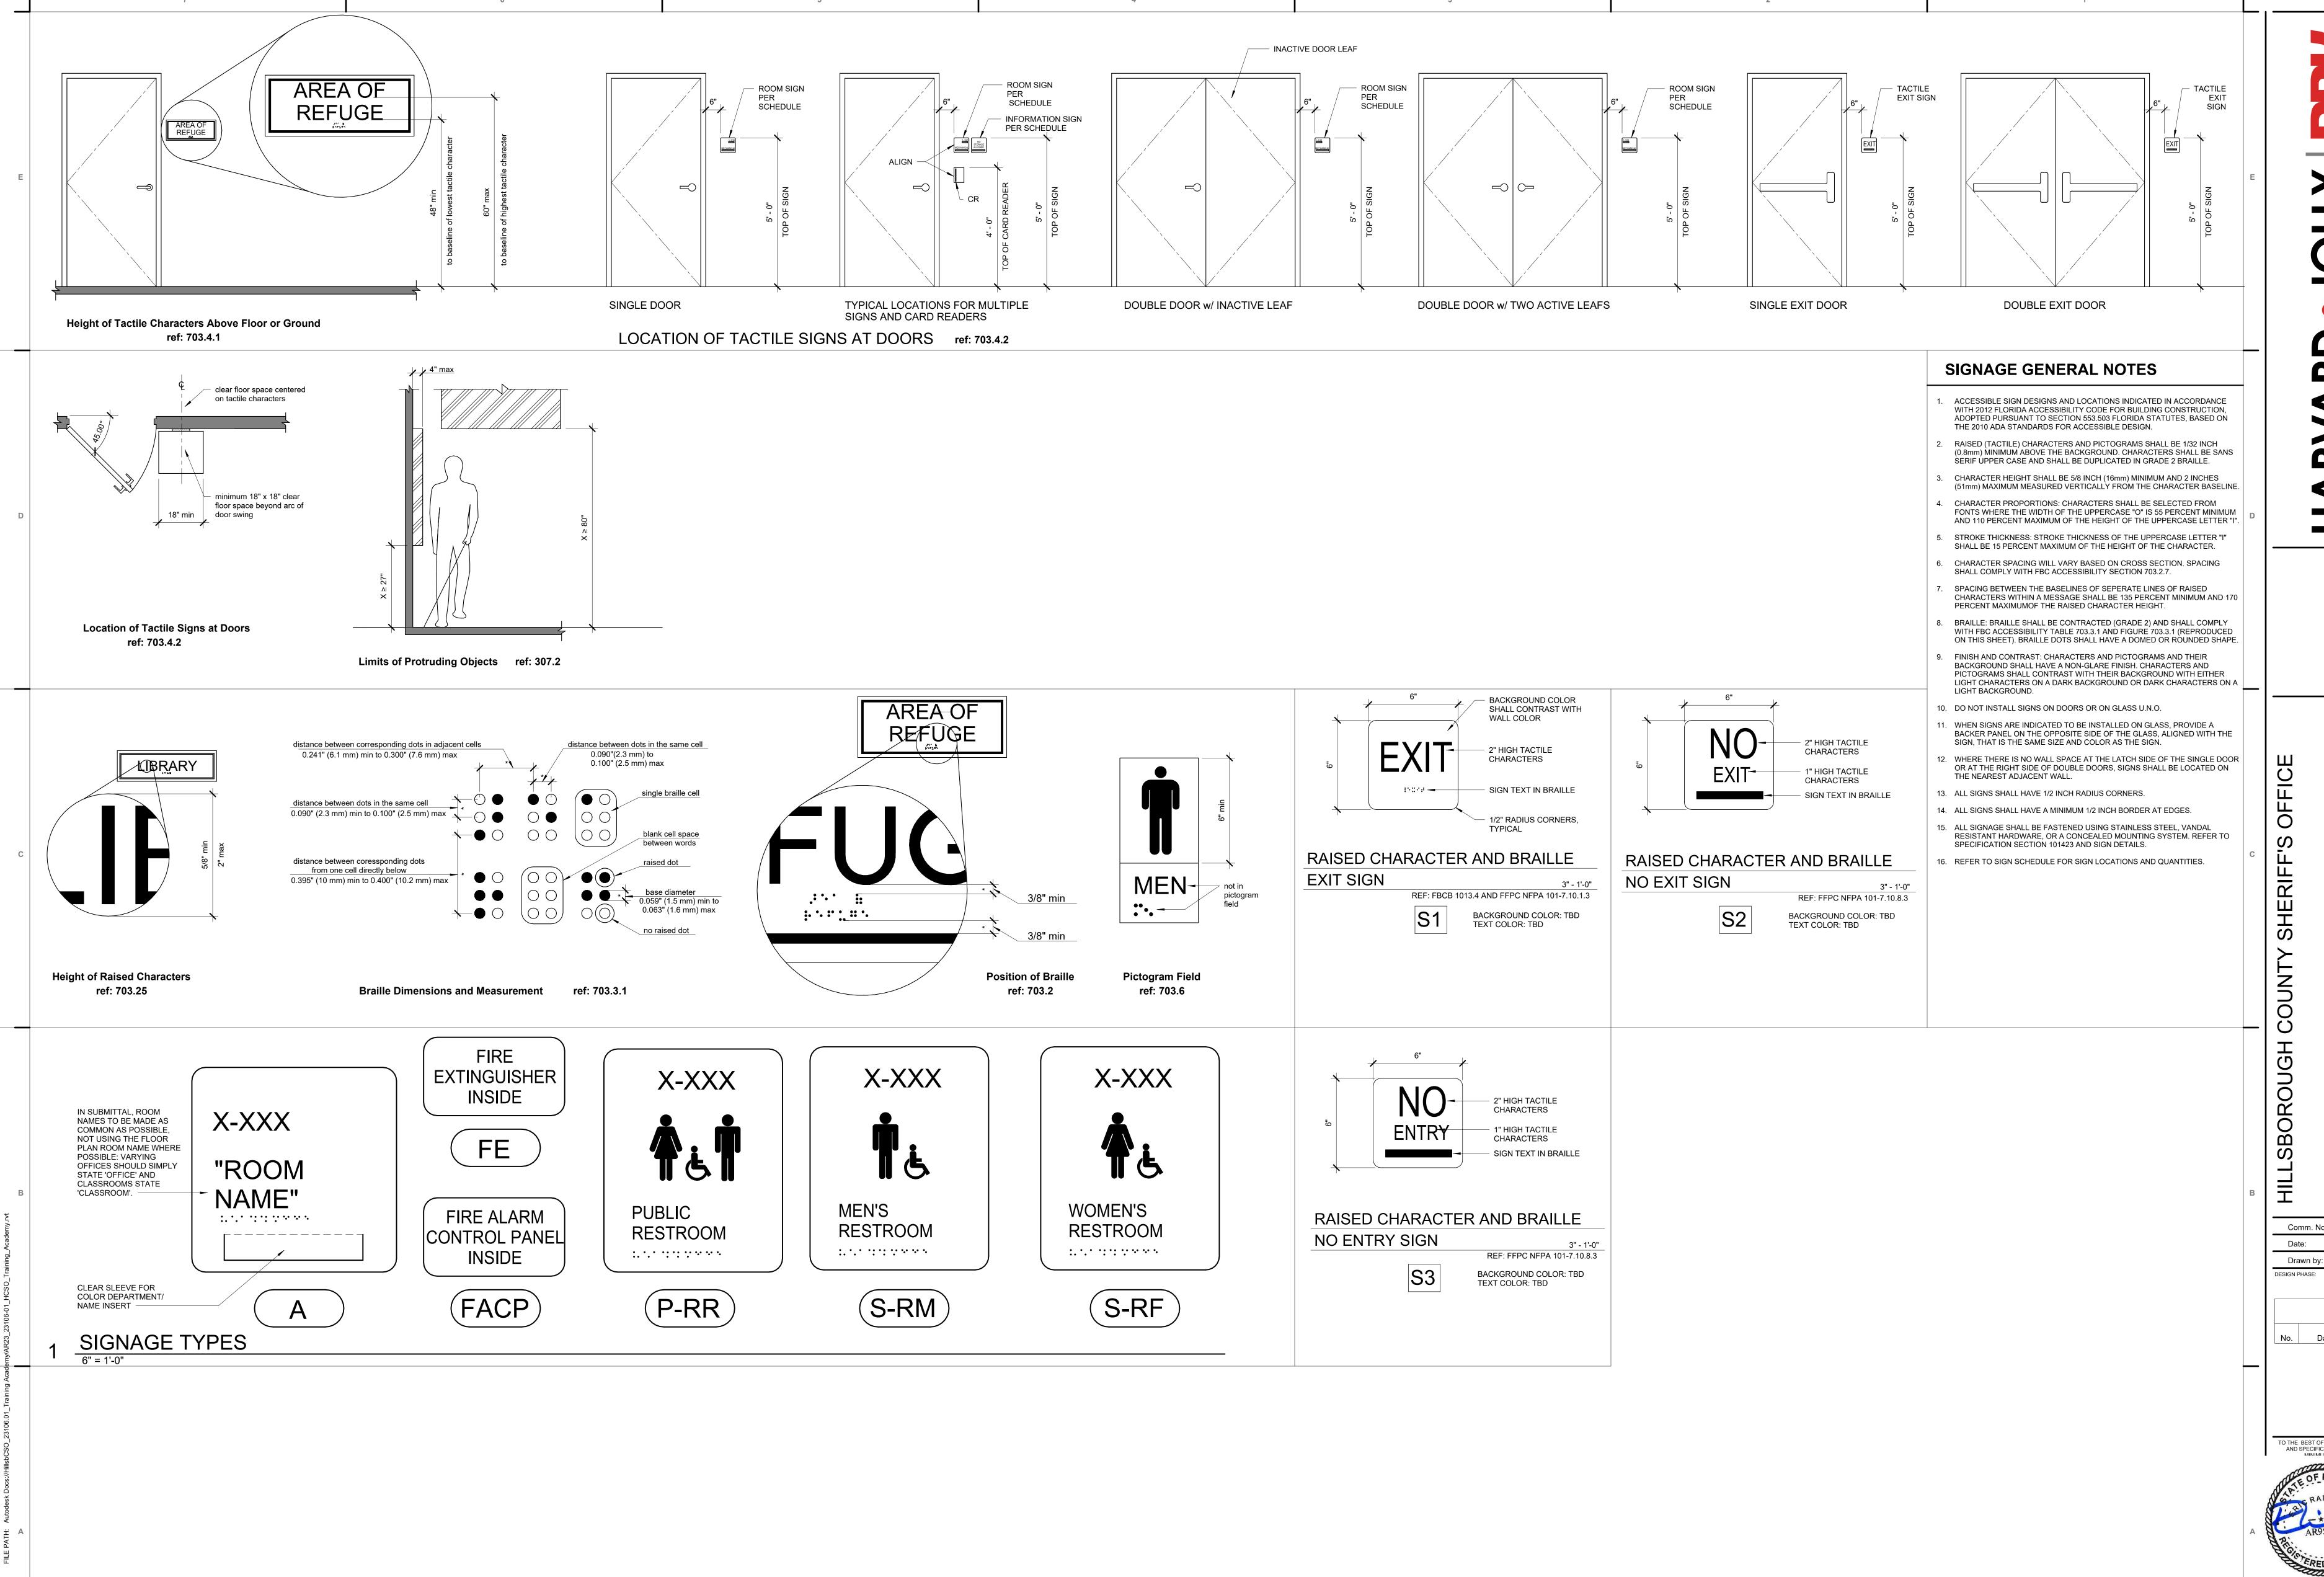



ACADEMY HORST ROAD, 1 TRAINING 10210 WINDH


Comm. No: 23106.01 Date: 8/15/25 Drawn by: ER

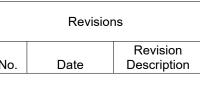

TO THE BEST OF MY KNOWLEDGE, THE PLANS AND SPECIFICATIONS COMPLY WITH THE

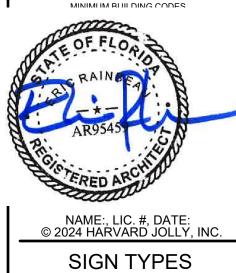

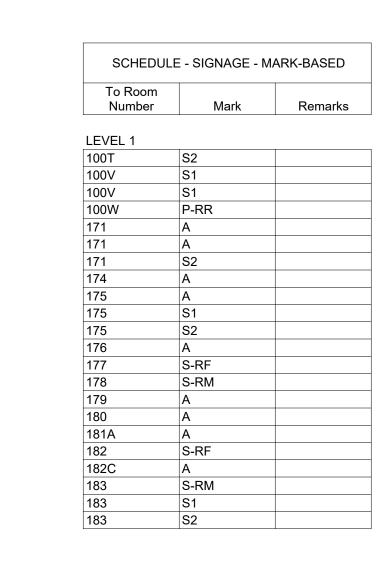

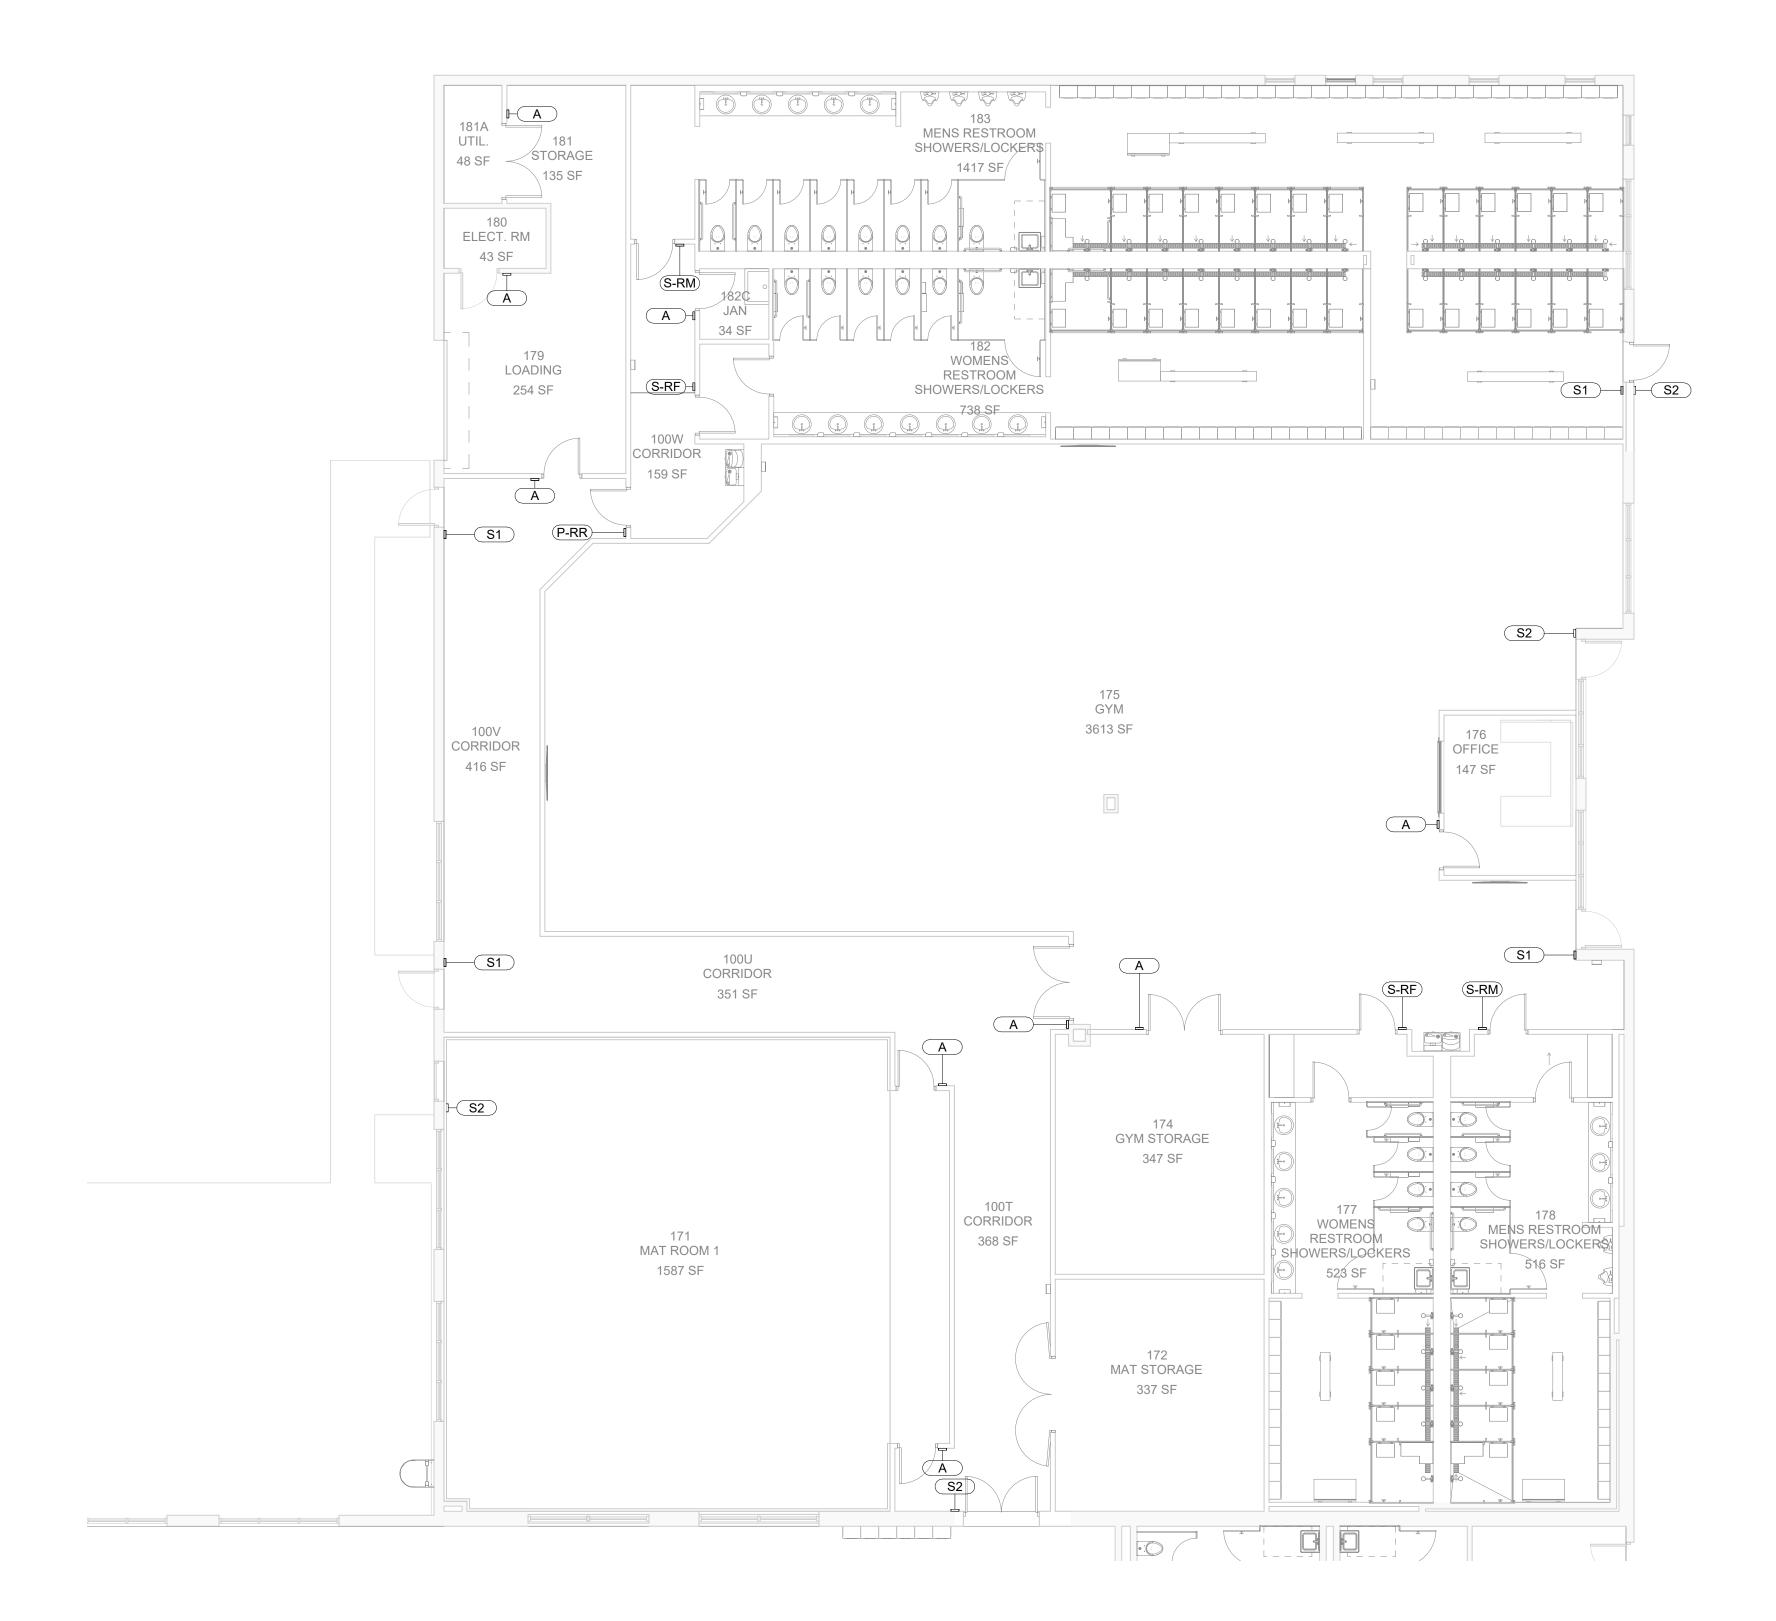

1 SIGNAGE PLAN - PHASE 1

HARVARD


HILLSBOROUGH COUNTY SHERIFF'S OFFICE
TRAINING ACADEMY
10210 WINDHORST ROAD, TAMPA, FL 33619


Comm. No: 23106.01

Date: 8/15/25

Drawn by: ER

DESIGN PHASE:

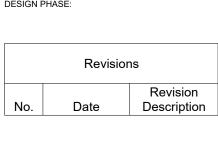

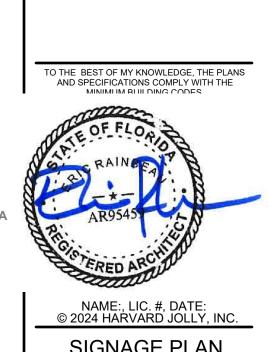

**KEY PLAN** 

SIGNAGE PLAN

A-805

**FLOOR PATTERN LEGEND** 


TO THE BEST OF MY KNOWLEDGE, THE PLANS AND SPECIFICATIONS COMPLY WITH THE

INTERIOR DESIGN FLOOR PLAN I-100


INTERIOR DESIGN FLOOR PLAN - PHASE 1

1/8" = 1'-0"


4 ID FLOOR PLAN - IDF ROOM 118

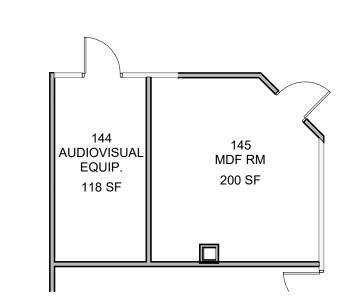

3 ID FLOOR PLAN - MDF ROOM 145

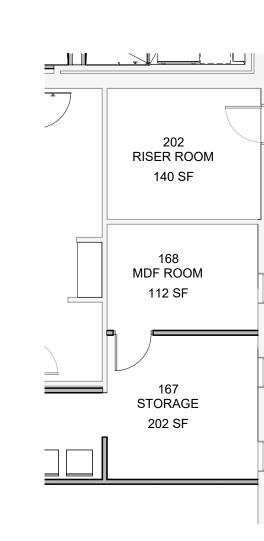

2 ID FLOOR PLAN - MDF ROOM 168

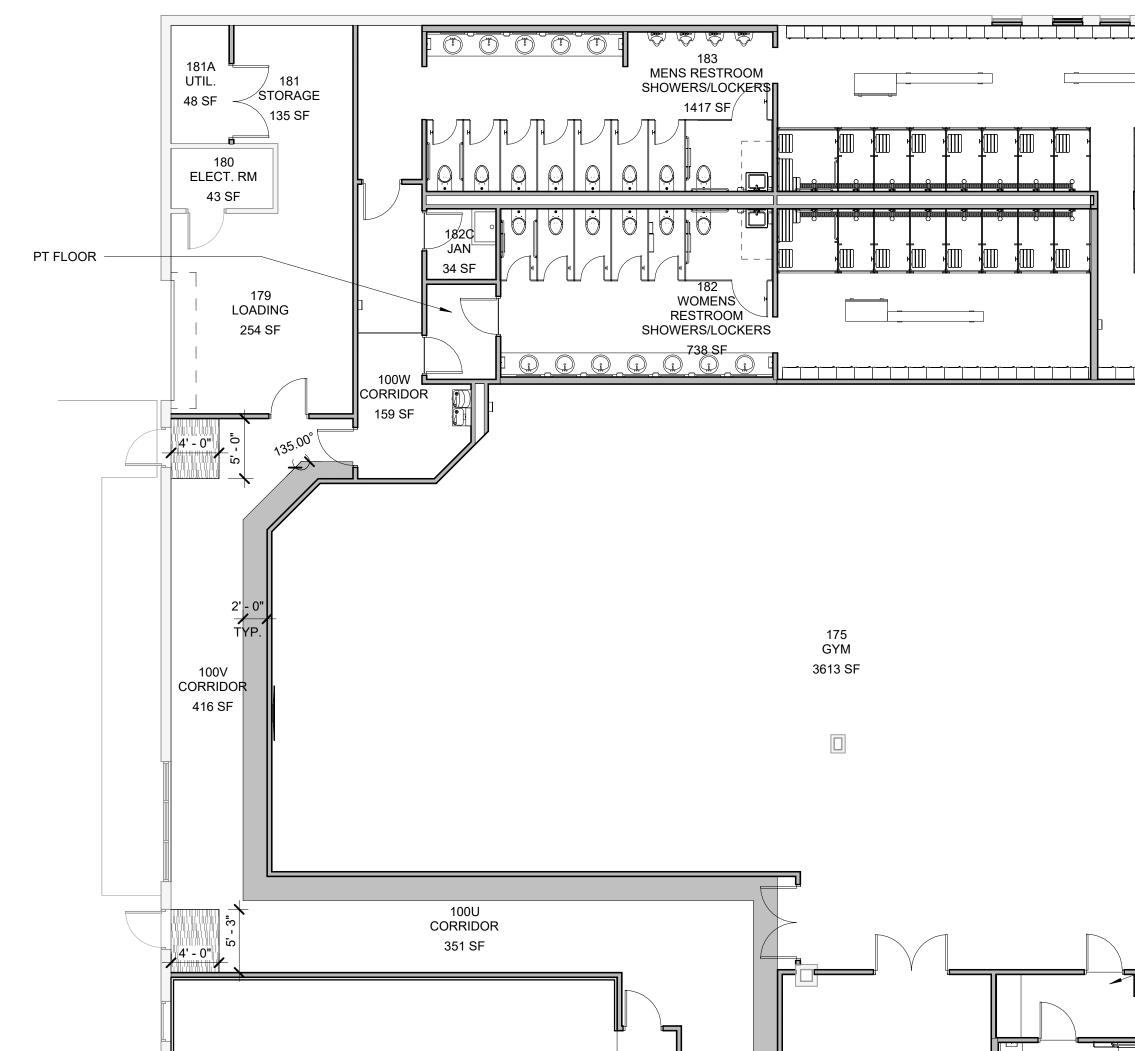

176 OFFICE

147 SF

174 GYM STORAGE

172 MAT STORAGE

WOMENS
RESTROOM
SHOWERS/LOCKERS

100T CORRIDOR

368 SF

— PT FLOOR

171 MAT ROOM 1